

ACTIVITY DETERMINATION

Project No. BGX6L

Dated 22 December 2023

Conflict of Interest ¹							
In this matter:							
 I have declared any possible conflict of interest Chief Executive, Land & Housing Corporation I do not consider I have any personal interests I will inform the Acting Chief Executive, Land aware of a possible conflict of interest. 	s that would affect my professional judgement.						
NameEmma:Nicholson:	Dated22 December 2023						

Having regard to the Determination Recommendation Report, the Statement of Compliance and the Review of Environmental Factors for this project addressing matters under Part 5 of the *Environmental Planning and Assessment Act 1979*, I determine that the activity proceed as described below and subject to the identified requirements set out in **Schedule 1**.

SITE IDENTIFICATION	
STREET ADDRESS	
Unit/Street No	Street or property name
3-5	Kelloway Avenue
Suburb, town or locality	Postcode
Camden	2570
Local Government Area(s)	Real property description (Lot and DP)
Camden	Lot 17 DP 219782 and Lot 18 DP 219782.
ACTIVITY DESCRIPTION	
ACTIVITY DESCRIPTION	
Provide a description of the activi	itv
	ction of a 2 storey boarding house consisting of 12 new generation
	rking for 3 cars, 1 motorbike and 4 bicycles, landscaping and tree
removal.	

Emma Nicholson A/Head of Policy and Innovation Land and Housing Corporation Department of Planning & Environment

Conflict of interest includes actual and potential. A conflict of interest includes pecuniary i.e. financial interests to you or a related party or non-pecuniary i.e. benefits to relatives, friends, business associates and personal causes, etc. This includes "related persons" as defined in the Property, Stock and Business Agency Act 2002.

SCHEDULE 1

IDENTIFIED REQUIREMENTS

PART A - Standard Identified Requirements

THE DEVELOPMENT

The following Identified Requirements are to ensure that the residential activity is carried out in accordance with the plans / documents and any amendments arising from the Review of Environmental Factors under Part 5 of the Environmental Planning & Assessment Act 1979, Section 171 of the Environmental Planning and Assessment Regulation 2021 and the requirements of State Environmental Planning Policy (Housing) 2021.

1. The development shall be carried out substantially in accordance with the following plans / documents as modified below and by any of the undermentioned identified requirements:

Note that the Landscape Plans prepared by *Place Design Group* have made an error in the title block for the revision date, as it is listed as "07/106/2023" and should read "07/06/2023".

Title / Name:	Drawing No. / Document Ref	Revision / Issue:	Date [dd.mm.yyyy]:	Prepared by:
Architectural Plans – Appendix A	·	·		
Coversheet	A000	01	8/12/2022	Sam Crawford Architects
Block Analysis Plan	A101	01	8/12/2022	Sam Crawford Architects
Site Analysis Plan	A102	01	8/12/2022	Sam Crawford Architects
Development Data	A104	01	8/12/2022	Sam Crawford Architects
Site Plan	A105	01	8/12/2022	Sam Crawford Architects
Ground Floor Plan	A106	01	8/12/2022	Sam Crawford Architects
First Floor Plan	A107	01	8/12/2022	Sam Crawford Architects
Roof Plan	A108	01	8/12/2022	Sam Crawford Architects
North Elevation (Street)	A201	01	8/12/2022	Sam Crawford Architects
South Elevation (Rear)	A202	01	8/12/2022	Sam Crawford Architects
East Elevation	A203	01	8/12/2022	Sam Crawford Architects
West Elevation	A204	01	8/12/2022	Sam Crawford Architects
Section (Long)	A301	01	8/12/2022	Sam Crawford Architects
Section (Cross 01)	A302	01	8/12/2022	Sam Crawford Architects
Section (Cross 02)	A303	01	8/12/2022	Sam Crawford Architects
Shadow Diagrams	A401	01	8/12/2022	Sam Crawford Architects
Solar Diagrams North West	A402	01	8/12/2022	Sam Crawford Architects
Solar Diagrams North East	A403	01	8/12/2022	Sam Crawford Architects
Solar Diagrams South West	A404	01	8/12/2022	Sam Crawford Architects
Solar Diagrams South West	A405	01	8/12/2022	Sam Crawford Architects
Material Schedule	A501	01	8/12/2022	Sam Crawford Architects
Photomontage	A601	01	8/12/2022	Sam Crawford Architects

Landscape Plans - Appendix B

Note: *Place Design Group* have made an error in the title block for the revision date, as it is listed as "07/106/2023", and should read "07/06/2023"

Title / Name:	Drawing No. / Document Ref	Revision /	Date [dd.mm.yyyy]:	Prepared by:				
Extent of works	Page No.3	02	7/06/2023	Place Design Group Pty Ltd				
Landscape Plan	Page No.4	02	7/06/2023	Place Design Group Pty Ltd				
Fencing Strategy and Materials Schedule	Page No.5	02	7/06/2023	Place Design Group Pty Lt				
Materials Schedule	Page No.6	02	7/06/2023	Place Design Group Pty Ltd				
Landscape Key Plan and Sections	Page No.7	02	7/06/2023	Place Design Group Pty Ltd				
Planting Schedule	Page No.8	02	7/06/2023	Place Design Group Pty Ltd				
Typical Landscape Details	Page No.9	02	7/06/2023	Place Design Group Pty Ltd				
Civil Plans – Appendix C		'	<u>'</u>					
Civil Construction Notes	80822228-CI- 0002	3	12/12/2022	Cardno Pty Ltd				
Proposed Drainage Stormwater Ground Floor Plan	80822228-CI- 0101	5	4/09/2023	Cardno Pty Ltd				
Proposed Drainage Stormwater Pits and Grated Drains Schedule	80822228-CI- 0102	4	31/08/2023	Cardno Pty Ltd				
Cut and Fill Plan	80822228-CI- 0111	1	12/12/2022	Cardno Pty Ltd				
Sedimentation and Erosion Control Plan	80822228-CI- 0121	3	12/12/2022	Cardno Pty Ltd				
Stormwater Standard Details Sheet 1	80822228-CI- 0201	3	12/12/2022	Cardno Pty Ltd				
Stormwater Standard Details Sheet 2	80822228-CI- 0202	2	12/12/2022	Cardno Pty Ltd				
Sedimentation and Erosion Control Details	80822228-CI- 0221	3	12/12/2022	Cardno Pty Ltd				
Survey Plan – Appendix D								
Detail & Contour Survey	201805-2 SHT1	2	8/11/2022	Total Surveying Solutions				
Detail & Contour Survey	201805 SHT1	-	30/10/2020	Total Surveying Solutions				
Detail & Contour Survey	201805 SHT1	-	12/10/2020	Total Surveying Solutions				
Notification Plans – Appendix E								
Cover Page	A801	01	8/12/2022	Sam Crawford Architects				
Site/Landscape Plan	A802	01	8/12/2022	Sam Crawford Architects				
Development Data	A803	01	8/12/2022	Sam Crawford Architects				
Elevations	A804	01	8/12/2022	Sam Crawford Architects				
Schedule of Finishes	A805	01	8/12/2022	Sam Crawford Architects				
Shadow Diagrams	A806	01	8/12/2022	Sam Crawford Architects				
Specialist Reports								
Access Review - Appendix H	-	05	05/05/2022	Morris Goding Access Consulting				
Arboricultural Assessment and Tree Protection Plan – Appendix J	-	03	12/09/2022	Vertical Tree Management & Consultancy				
BASIX Certificate - Appendix K	1295786M_02	-	28/04/2023	Northrop Consulting Engineers Pty Ltd				
BCA Report - Appendix L	202241-01	D	24/04/2023	Mckenzie group				

Title / Name:	Drawing No. / Document Ref	Revision / Issue:	Date [dd.mm.yyyy]:	Prepared by:
NatHERS Certificate - Appendix N	No.000828861	-	11/12/2022	Northrop Consulting Engineers Pty Ltd
Character Statement - Appendix O	-	С	08/12/2022	Sam Crawford Architects
Geotechnical Investigation – Appendix P	9557/1-AA-R3	R3	02/08/2023	Geotech Testing Pty Ltd
Waste Management Plan – Appendix R	20165	-	00/12/2022	Dickens Solutions
Traffic and Parking Impact Assessment Report – Appendix S	80822228:HC	-	09/12/2022	Cardno Pty Ltd
Traffic Noise Impact Assessment – Appendix T	20220223	3	27/02/2023	Building Services Engineers
Soil Characterisation Report – Appendix U	3387	0	16/04/1963	ADE Consulting Group
Cost Estimate	MBM0579- 0017	01	22/12/2023	МВМ

- 2. All building work is to be undertaken in accordance with the National Construction Code and referenced Australian Standards.
- **3.** All commitments listed in the BASIX certificate and stamped plans shall be implemented.
- 4. All construction documentation and building work is to be certified in accordance with Section 6.28 of the Environmental Planning and Assessment Act 1979.
- 5. The land the subject of this determination shall be consolidated into a single lot. The plan of consolidation shall be lodged at the NSW Land Registry Services and shall be registered prior to the occupation of the development. A copy of the registered plan shall be provided to the Land & Housing Corporation.

OPERATIONAL MATTERS

The following Identified Requirements relate to the use of the site and are to ensure that the activity and its operation do not interfere with the amenity of the surrounding area.

Stormwater Run-off

- 6. Stormwater shall be collected within the site and conveyed in a pipeline to the appropriate gutter or drain under the control of Camden Council substantially in accordance with the approved concept stormwater drainage plans.
- 7. Alterations to the natural surface contours or surface absorption characteristics of the site shall not impede, increase or divert natural surface water runoff so as to cause a nuisance to adjoining property owners.
- **8.** All driveways shall be graded in such a manner as to provide continuous surface drainage flow paths to the appropriate points of discharge.
- **9.** To prevent water from entering buildings, surface waters shall be collected and diverted clear of the buildings by a sub-surface / surface drainage system.

Vehicular Access & Parking

- 10. A concrete vehicular crossing and layback shall be provided at the entrance/exit to the property. The crossing and layback shall be constructed in accordance with Camden Council's standard requirements for residential crossings. Council shall be provided with plans for the crossing and layback together with the payment of any Council inspection fees.
- 11. Particular care shall be taken in the location of vehicular crossings and/or laybacks to avoid poles, pits etc. The cost of any necessary adjustments to utility mains and services associated with the construction of the layback / driveway shall be borne by the Land & Housing Corporation. Obsolete gutter layback(s) shall be constructed as kerb in accordance with Camden Council's standards.

Note:

It is recommended that discussion be held with the relevant authorities before construction works commence.

12. Car parking spaces and driveways shall be constructed of concrete or other approved hard surfaced materials. The spaces must be clear of obstructions and columns, permanently line marked and provided with adequate manoeuvring facilities. The design of these spaces must comply with AS 2890.1.

Site Works

- 13. All soil erosion and sediment control measures required to be put in place prior to the commencement of demolition / construction works shall be maintained during the entire period of the works until all the disturbed areas are restored by turfing, paving or revegetation. Soil erosion and sediment control measures shall be designed in accordance with the guidelines set-out in the Blue Book *Managing Urban Stormwater:* Soils and Construction (4th edition, Landcom, 2004).
- 14. An appropriately qualified person shall design retaining walls or other methods necessary to prevent the movement of excavated or filled ground, including associated stormwater drainage measures.

Building Siting

15. All buildings shall be sited well clear of any easements affecting the site. The builder shall ascertain if any easements do exist and, if they do, obtain full details of such prior to construction commencing.

Smoke Detection System(s)

- 16. Smoke detection systems shall be installed throughout the building in accordance with requirements of Clause E2.2a of the Building Code of Australia. Detectors and alarms shall comply with AS 3786 and AS 1670 and must:
 - i. be connected to a permanent 240V power supply; and
 - ii. be provided with a battery backup to activate the alarm unit in the event of failure of the permanent power supply.

Site Soil Contamination

17. If the site is identified as being potentially affected by soil contamination, it shall be inspected by a suitably qualified person to identify any contaminated or hazardous material present. A proposal for remediation shall be prepared, which may include preparation of a Remedial Action Plan, and remediation shall be carried out in accordance with the proposal. A Validation Report, prepared in accordance with Environment Protection Authority requirements, shall be obtained from a qualified expert on completion of the remediation work to verify that the site is suitable for the intended residential use. A copy of the Validation Report shall be provided to the Land & Housing Corporation on completion of the remediation works.

Landscaping

- 18. Landscaping shall be carried out substantially in accordance with the approved landscape plan(s) and maintained for a period of 12 months by the building contractor. Camden Council shall be consulted in relation to the planting of any street trees.
- 19. All scheduled plant stock shall be pre-ordered, prior to commencement of construction or 3 months prior to the commencement of landscape construction works, whichever occurs sooner, for the supply to the site on time for installation. The builder shall provide written confirmation of the order to the Land & Housing Corporation.

Tree Removal

20. Removal of trees within the boundaries of the site is to be carried out in accordance with the trees shown for removal on the approved Landscape Plan and Arboricultural Assessment and Tree Protection Plan and no other trees shall be removed without further approval(s).

Fencing

21. All front fencing and gates shall be constructed wholly within the boundaries of the site. Any gates associated with the fencing shall swing inwards towards the site.

Provision of Letterbox Facilities

22. Suitable letterbox facilities are to be provided in accordance with Australia Post specifications.

Public Liability Insurance

23. A valid public liability insurance policy of at least \$10M shall be maintained throughout the demolition / construction works by the contractor.

PRIOR TO ANY WORK COMMENCING ON THE SITE

The following Identified Requirements are to be complied with prior to any work commencing on the site, including demolition.

Disconnection of Services

24. All services that are required to be disconnected shall be appropriately disconnected and made safe prior to commencement of the demolition / construction works. The

various service authorities shall be consulted regarding their requirements for the disconnection of services.

25. All existing services within the boundary to remain live shall be identified, pegged and made safe.

Utilities Service Provider Notification

26. The construction plans shall be submitted to the appropriate water utility's office (e.g. Sydney Water office) to determine whether or not the development will affect the utility's sewer and water mains, stormwater drains and any easements.

Note:

If the development complies with water utility's requirements, the plans will be stamped indicating that no further requirements are necessary.

Council Notification

27. Camden Council shall be advised in writing, of the date it is intended to commence work, including demolition. A minimum period of 5 working days notification shall be given.

Site Safety

- **28.** A sign shall be erected in a prominent position on any site on which demolition or building work is being carried out:
 - (a) showing the name, address and telephone number of the responsible Land & Housing Corporation officer for the work, and
 - (b) showing the name of the principal contractor (if any) and a telephone number on which that person may be contacted outside working hours, and
 - (c) stating that unauthorised entry to the work site is prohibited.

The sign shall be maintained while the work is being carried out but shall be removed when the work has been completed.

Note:

This requirement does not apply in relation to building work that is carried out inside an existing building that does not affect the external walls of the building.

29. A minimum 1.8m high security fence or Class A / Class B (overhead) hoarding must be erected between the work site and any public place prior to demolition / construction. Access to the site shall be restricted to authorised persons only and the site shall be secured against unauthorised entry when demolition / construction work is not in progress or the site is otherwise unoccupied.

Note:

Approval from the relevant roads authority will be required under Section 138 of the Roads Act 1993 where a Class A or B hoarding encroaches onto the footpath of / or a public thoroughfare within a classified road.

30. No building materials are to be stored on the footpath or roadway.

Site Facilities

- **31.** The following facilities shall be installed on the site:
 - (a) Toilet facilities shall be provided at the rate of 1 toilet for every 20 persons or part thereof employed at the site. Each toilet provided shall be a standard flushing toilet and shall be connected to a public sewer or if connection to a public sewer is not practicable, to an accredited sewerage management facility provided by Camden Council or if this is not practicable to some other council approved management facility.
 - (b) Adequate refuse disposal methods and builders storage facilities. Builders' wastes, materials or sheds shall not to be placed on any property other than that which this approval relates to.
- **32.** Access to the site shall only be provided via an all-weather driveway on the property and is not to be provided from any other site.

Protection of Trees

33. Trees and other vegetation that are to be retained on site shall be protected prior to the commencement of works and for the duration of the construction period in accordance with the details provided in the Arboricultural Assessment and Tree Protection Plan.

Waste Management

34. A final Waste Management Plan shall be prepared and submitted to the Land & Housing Corporation by the building contractor prior to the commencement of demolition / construction. The plan shall detail the amount of waste material and the destination of all materials, recyclable and non-recyclable.

PRIOR TO ANY CONSTRUCTION WORK COMMENCING ON SITE

The following Identified Requirements are to be complied with prior to any construction works occurring on the site, excluding demolition.

Service Authority Clearances

35. A compliance certificate, or other evidence, shall be obtained from the Sydney Water, confirming service availability prior to work commencing.

Note:

Payment of water and/or sewer service charges and/or a notice of requirements for works to be carried out during construction / prior to occupation may be applicable prior to issue of the compliance certificate.

- **36.** A written clearance from an electricity supply authority stating that electrical services are available to the site, or that arrangements have been entered into for the provision of services to the site, shall be obtained prior to work commencing.
- **37.** A certificate from an approved telecommunications carrier certifying that satisfactory arrangements have been made for the provision of underground telephone services, to the site and to each dwelling, shall be obtained prior to work commencing.

38. Where the site is to be connected to reticulated gas, a certificate from an approved gas carrier to certify that satisfactory arrangements have been made to ensure the provision of underground gas services to each dwelling in the development shall be obtained prior to work commencing.

Stormwater Disposal

- 39. A detailed stormwater drainage plan(s), substantially in accordance with the approved concept stormwater drainage plan(s), shall be prepared and submitted to the Land & Housing Corporation. Any on-site detention system shall be designed in accordance with the relevant catchment authority's requirements (e.g. the Upper Parramatta River Catchment Trust On-site Detention Handbook) and/or Camden Council's drainage code.
- 40. Where a drainage easement is required, proof of lodgement of the plan of the drainage easement at the NSW Land Registry Services shall be submitted to the Land & Housing Corporation prior to commencement of works. Registration of the plan of easement shall be completed prior to occupation of the development and a copy of the registered plan shall be provided to the Land & Housing Corporation.

DURING CONSTRUCTION WORKS

The following Identified Requirements are to be complied with whilst demolition and construction works are occurring on the site.

Landfill

- **41.** Where site filling is necessary, a minimum of 95% standard compacting shall be achieved and certified by a NATA registered Soils Lab.
- **42.** Land fill materials must satisfy the following requirements:
 - i. be Virgin Excavated Natural Matter (VENM);
 - ii. be free of slag, hazardous, contaminated, putrescible, toxic or radio-active matter; and
 - iii. be free of industrial waste and building debris.

Heritage

- 43. Historic and indigenous archaeological sites and relics are protected under the Heritage Act 1977 and National Parks and Wildlife Act 1974, respectively. Should any relics be uncovered during the course of the approved works, work must cease immediately in the affected area. Subsequently, in cases where historical items have been uncovered, the Department of Planning and Environment must be contacted.
- **44.** All workers / contractors on the site shall be informed of their obligations, under the Heritage Act and *National Parks and Wildlife Act 1974*, that it is illegal to disturb, damage or destroy a relic without the prior approval.

Survey Reports

45. Survey reports shall be submitted by the building contractor to the Land & Housing Corporation prior to the placement of the footings / slab and on completion of the

dwellings to verify the correct position of the structures in relation to the allotment boundaries.

Hours of Demolition / Construction / Civil Work

46. Demolition / construction / civil work shall only occur on the site between the hours of 7.00am to 5.00pm Monday to Saturday with no work permitted on Sundays or public holidays.

Excavation & Backfilling

47. All excavations and backfilling associated with the demolition or erection of building(s) shall be executed safely and in accordance with appropriate professional standards. All such work shall be guarded and protected to prevent it from being dangerous to life or property.

Pollution Control

- **48.** Any noise generated during the construction of the development shall not exceed the limits specified in the July 2009 Interim Construction Noise Guidelines, published by the former Department of Environment and Climate Change.
- **49.** No fires shall be lit or waste materials burnt on the site.
- **50.** No washing of concrete forms or trucks shall occur on the site.
- 51. Any contamination / spills on the site during construction works shall be actively managed and reported immediately to appropriate regulatory authorities to minimise any potential damage to the environment.
- **52.** Dust generation during demolition / construction shall be controlled using regular control measures such as on site watering or damp cloth fences.
- **53.** All vehicles transporting loose materials and travelling on public roads shall be secured (i.e. closed tail gate and covered) to minimise dust generation.
- 54. Non-recyclable waste and containers shall be regularly collected and disposed of at a licensed landfill or other disposal site in accordance with details set out in the final Waste Management Plan.

Impact of Construction Works

- **55.** The Land & Housing Corporation shall bear the cost of any necessary adjustments to utility mains and services.
- **56.** Care shall be taken to prevent any damage to adjoining properties. The building contractor shall be liable to pay compensation to any adjoining owner if, due to demolition/construction works, damage is caused to such adjoining property.

Termite Protection

57. To protect buildings from subterranean termite, termite barriers installed in accordance with AS 3660.1, shall be placed on the underside and in penetrations of the concrete slab floor.

In addition, a durable notice must be permanently fixed inside the meter box indicating:

- (a) the method of protection;
- (b) the date of installation of the system;
- (c) where a chemical barrier is used, its life expectancy as listed on the National Registration Authority label; and
- (d) the need to maintain and inspect the system on a regular basis.

PRIOR TO OCCUPATION OF THE DEVELOPMENT

The following Identified Requirements are to be complied with prior to the occupation of the development.

General

58. The use or occupation of the development shall not commence until all the Identified Requirements of this determination have been complied with.

Council Infrastructure Damage

59. The cost of repairing any damage caused to Camden Council's assets in the vicinity of the site as a result of demolition / construction works shall be met in full by the building contractor.

Stormwater Drainage

- 60. Prior to occupation, a Work As Executed Plan shall be prepared by the building contractor clearly showing all aspects of the constructed stormwater drainage system, including any on-site detention system. The plan shall demonstrate general compliance with the approved concept stormwater drainage plan(s) and shall include:
 - sufficient levels and dimensions to verify the constructed storage volumes; and
 - location and surface levels of all pits; and
 - invert levels of the internal drainage lines, orifice plates fitted and levels within the outlet control pits; and
 - finished floor levels of all structures; and
 - verification that any required trash screens have been installed; and
 - locations and levels of any overland flow paths; and
 - verification that any drainage lines are located wholly within easements, where applicable.

The Work-As-Executed Plan information shall be shown on the final civil works drawings.

A positive covenant and restriction-as-to-user shall be placed over the onsite detention system in accordance with Camden Council's on-site detention policy to ensure that the system will be adequately maintained. The positive covenant and restriction-as-to-user shall be registered at NSW Land Registry Services prior to occupation. A copy of the registered restriction-as-to-user shall be provided to the Land & Housing Corporation and Camden Council.

PART B - Additional Identified Requirements

Requirements Resulting from Assessment

61. The material recommendations contained within the Traffic Noise Impact Assessment (listed in Identified Requirement 1 above) are to be shown in the detailed construction drawings.

Requirements Resulting from Council Comments

62. All Architectural, Landscape and Civil Plans are to be updated to reflect the 1m minimum clearance from the driveway to the stormwater street pit located at the street frontage consistent with the Site Plan (Plan No A105 Rev 01).

ADVISORY NOTES

- i. Approval of this development activity does not imply or infer compliance with Section 23 of the *Disability Discrimination Act 1992*. Refer to AS 1428.1 and the Building Code of Australia for detailed guidance.
- ii. Information regarding the location of underground services may be obtained from Dial Before You Dig at www.1100.com.au or by dialing 1100.



Decision Statement

Project No. BGX6L

Street or property name
Kelloway Avenue
Postcode
2570
Real property description (Lot and DP)
Lot 17 DP 219782 and Lot 18 DP 219782.
on of a 2 storey boarding house consisting of 12 new generation
king for 3 cars, 1 motorbike and 4 bicycles, landscaping and tree

The Land & Housing Corporation (LAHC) has proposed the above activity under the provisions of *State Environmental Planning Policy (Housing) 2021* (Housing SEPP) which requires determination under Part 5 of the *Environmental Planning & Assessment Act 1979* (EP&A Act). This Decision Statement relates to the Review of Environmental Factors (REF) for the above activity prepared under Part 5 of the EP&A Act and the *Environmental Planning and Assessment Regulation 2021*.

Based on the REF document and supporting documentation, including advice from Camden Council a decision to proceed with the proposed activity has been made. This decision included consideration of the following:

Significant Impact on the Environment

- The proposed activity is not likely to have a significant impact on the environment and therefore an EIS is not required.
- The proposed activity will not be carried out in a declared area of outstanding biodiversity value and is not likely to significantly affect threatened species, populations or ecological communities, or their habitats or impact biodiversity values, meaning a SIS and/or BDAR is not required.

Reasons for the Decision

 Following an assessment of the proposed activity and associated environmental impacts within the REF document it was decided that the proposed development will have economic and social

Decision Statement: 3-5 Kelloway Avenue, Camden, NSW 2570

benefits and any minor short-term impacts on the environment or surrounding properties can be appropriately mitigated.

 The proposed development will assist in the provision of much needed social and affordable housing and assist in addressing the existing and growing demand for housing in the local government area.

Mitigation Measures

 Mitigation measures are required to minimise or manage environmental impacts and are detailed throughout the REF and specifically within Section 7. All mitigation measures are detailed within the Activity Determination and have been imposed to minimise the impact on the surrounding environment, ensure appropriate site safety and to ensure legislative compliance.

Signed.....

Dated 22 December 2023

Emma Nicholson
Acting Head of Policy and Innovation
Land and Housing Corporation
Department of Planning & Environment



PART 5 ACTIVITY, PROPOSED BOARDING HOUSE, BGX6L

3-5 KELLOWAY AVENUE CAMDEN NSW 2570 -DHARAWAL COUNTRY LOT 17 DP 219782, LOT 18 DP 219782,

FOR LAND & HOUSING CORPORATION (LAHC)

PLANNING APPROVAL: DRAWING LIST

A000	COVER PAGE	N.T.S.
100 PL	ANS	
A101	BLOCK ANALYSIS PLAN	N.T.S.
A102	SITE ANALYSIS PLAN	1:200
A104	DEVELOPMENT DATA	N.T.S.
A105	SITE PLAN	1:200
A106	GROUND FLOOR PLAN	1:100
A107	FIRST FLOOR PLAN	1:100
A108	ROOF PLAN	1:100
A200 EI	LEVATIONS	
A201	NORTH ELEVATION (STREET)	1:100
A202	SOUTH ELEVATION (REAR)	1:100
A203	EAST ELEVATION	1:100
A204	WEST ELEVATION	1:100
A300 SI	ECTIONS	
A301	SECTION (LONG)	1:100
A302	SECTION (CROSS 01)	1:100
A303	SECTION (CROSS 02)	1:100
A400 SI	HADOW DIAGRAMS	
A401	SHADOW DIAGRAMS	1:500
A402	SOLAR DIAGRAMS NORTH WEST	N.T.S.
A403	SOLAR DIAGRAMS NORTH EAST	N.T.S.
A404	SOLAR DIAGRAMS SOUTH WEST	N.T.S.
A405	SOLAR DIAGRAMS SOUTH EAST	N.T.S.
A500 M	ATERIALS	
A501	MATERIAL SCHEDULE	N.T.S.
A600 PI	HOTOMONTAGE	
A601	PHOTOMONTAGE	N.T.S.

Please refer to Page 2 for BASIX pathway summary



LOCATION PLAN (N.T.S.)



BASIX CERTIFICATION



All recommendations in the Access Report (by MGAC dated 9 Feb 2023), BCA report (by Mckenzie Group dated 9 Feb 2023), and Traffic Noise Impact Assessment (by BSE dated 6 April 2023) report are to be complied

CONSULTANTS LIST

ARCHITECT	Sam Crawford Architects					
	Unit 4, 30 Wilson Street, Newtown 2042 P 02 9519 6800					
ACCESS CONSULTANT	Morris Goding Access Consulting					
	Suite 106, 56 Bowman Street, Pyrmont 2009 P 02 9692 9322					
BCA CONSULTANT	McKenzie Group Consulting					
	197/189 Kent St, Sydney 2000 P 02 8298 6800					
CIVIL ENGINEER	Cardno					
	Level 9, 203 Pacific Highway, St Leonards 2065 P 02 9496 7700					
LANDSCAPE ARCHITECT	Place Design Group					
	3b/830-832 Elizabeth St, Waterloo 2017 P 02 9290 3300					
ELECTRICAL, FIRE,	Northrop Consulting Engineers					
HYDRAULIC, MECHANICAL, STRUCTURAL & SUSTAINABILITY	Level 1, 215 Pacific Highway Charlestown NSW P 02 4943 1777					
TRAFFIC ENGINEER	Cardno					
	Level 9, 203 Pacific Highway, St Leonards 2065 P 02 9496 7700					
ACCOUSTIC ENGINEER	BSE					
	Level 2, 121 Walker Street, North Sydney 2060 P 02 9922 5200					
ARBORIST	Anderson Environmental					
	Suite 19, 103 George Street, Parramatta 2150 P 1300 302 507					
	+					
WASTE MANAGEMENT CONSULTANT	Dickens Solutions					

DESCRIPTION
Part 5 submission PHONE: 1800 738 718 NSW WEBSITE: https://www.dpie.nsw.gov.au/

samcrawfordarchitects

TELEPHONE +612 9519 6800

LAND & HOUSING CORPORATION (LAHC)

CAMDEN BOARDING HOUSE

LOT 17/ DP 219782 LOT 18/ DP 219782


BGX6L N.T.S.


COVER PAGE

A000

01

3-5 KELLOWAY AVENUE CAMDEN NSW 2570 - DHARAWAL COUNTRY

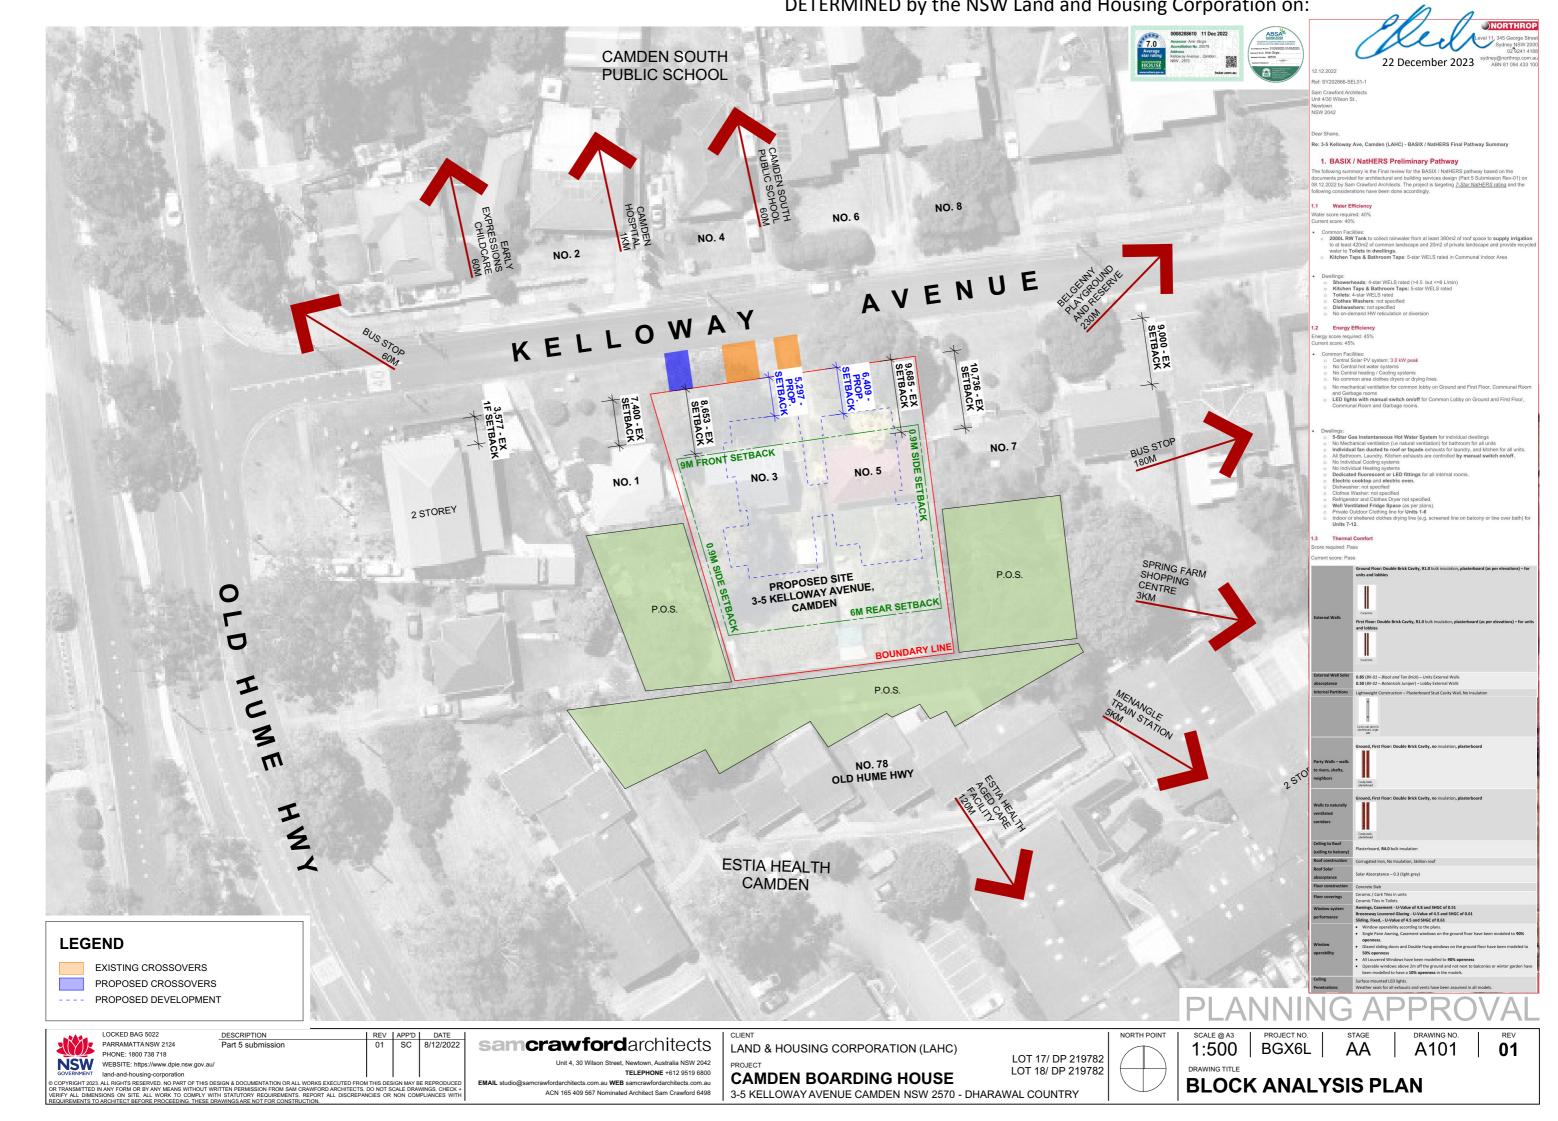

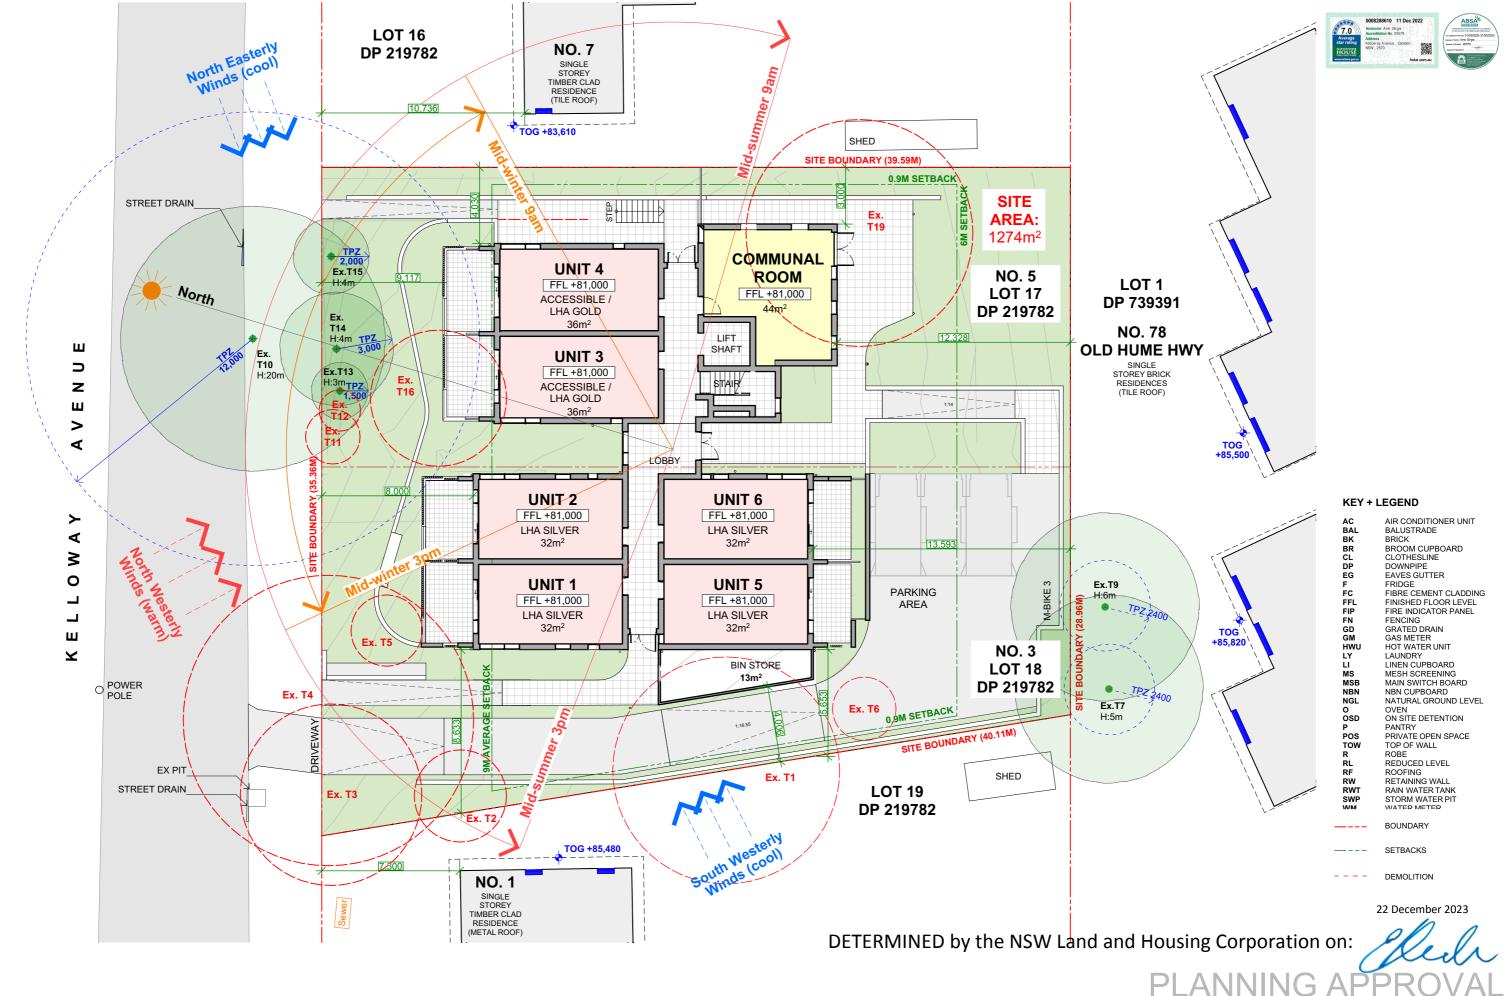

LOCKED BAG 5022 DESCRIPTION
Part 5 submissio REV APP'D 01 SC NORTH POINT SCALE @ A3 **samcrawford**architects PARRAMATTANSW 2124 LAND & HOUSING CORPORATION (LAHC) 1:200 PHONE: 1800 738 718 LOT 17/ DP 219782 NSW WEBSITE: https://www.dpie.nsw.gov.au/ LOT 18/ DP 219782 TELEPHONE +612 9519 6800 **CAMDEN BOARDING HOUSE** SITE ANALYSIS PLAN COPYRIGHT 2023. ALL RIGHTS RESERVED. NO PART OF THIS DESIGN & DOCUMENTATION OR ALL WORKS EXECUTED FROM THIS DESIGN MAY BE REPRODUCEL R TRANSMITTED IN ANY FORM OR BY ANY MEANS WITHOUT WRITTEN PERMISSION FROM SAM GRAWFORD ARCHIES. DO NOT SCALE DRAWINGS. CHER RIFFY ALL DIMENSIONS ON SITE. ALL WORK TO COMPLY WITH STATUTIORY REQUIREMENTS. REPORT ALL DISCREPANCIES OR NON COMPLIANCES WITH QUIREMENTS TO ARCHITECT BEFORE PROCEEDING. THESE DRAWINGS SARE NOT FOR CONSTRUCTION. om.au WEB samcrawfordarchitects.com.au ACN 165 409 567 Nominated Architect Sam Crawford 6498 3-5 KELLOWAY AVENUE CAMDEN NSW 2570 - DHARAWAL COUNTRY

PROJECT NO. BGX6L

A102 01






DEVELOPMENT DATA BOARDING HOUSE PART 5 APPROVAL PATHWAY – SH SEPP s.29									
Job Reference	BGX6L								
Locality / Suburb		Camden							
Street Address		3-5 Kelloway Avenue							
Lot Number(s) & Deposited Plan		Lots 17 & 18 in DP 219782							
SITE AREA (sqm)		1274 (survey)							
NUMBER OF EXISTING LOTS		2							
PROPOSED GFA* (sqm)		567sqm							
ACCESSIBLE AREA				١	Yes				


			No of Residents Required room					
ROOMS	Number	Type*	Residents Housing SEPP CI. 25(1)(b) = Max. 2	Required room size (excl. wet areas) Housing SEPP Cl. 25(1)(a) & (h) = Min 12m²/16m² - Max 25m² excl. area for kitchen or bathroom	Total Area (incl. kitchen & bathroom areas)	POS *No specified min. areas r'qd under Housing SEPP		
ROOMS	1	ground	1	20	32	8	11	
	2	ground	1	20	32	8	10	
	3 (Accessible)	ground	1	23	36	8	11	
	4 (Accessible)	ground	1	23	36	8	11	
	5	ground	1	20	32	8	11	
	6	ground	1	20	32	8	12	
	7	1st	1	20	32	8	6	
	8	1st	1	20	32	8	6	
	9	1st 1st	1	24	36 36	8	6	
	11	1st	1	20	32	8	6	
	12	1st	1	20	32	8	6	
	Control		Re	quirement		Pro	osed	
	Housing	SEPP		_				
BUILDING HEIGHT	Camde	n LEP		9m 9.5m			8 m 8m	
	Housing	CEDD	 	5		ļ		
FSR	Cl. 24(.		Not adopt	ed no maximum unde	r LEP or DCP		GFA 45:1	
MIN. LOT SIZE	Housing Cl. 25(1	; SEPP)(g)(i)		600m ²		1274 m	² (survey)	
MAX. NO. ROOMS	Housing Cl. 25(Max. 12 rooms in R2 zo	one	12 rooms		
CAR PARKING	Housing SEPP Cl.24(2)(i) *DCP rate for BH is as per ARH SEPP	Accessible	1	2 x 0.2 = (2.4) 3 car spa	3 spaces			
MOTORCYCLE PARKING	Housing Cl. 25(Adequate bicycle and motorcycle parking spaces 1 Motorcycle s					
BICYCLE PARKING	Housing Cl. 25(Adequate bi	cycle and motorcycle	parking spaces	4 Bicyc	e spaces	
	Housing SEPP Cl. 25(2)(b) =	Front Setback	in establish adjoining s	9.0m average Western Block: 8m Eastern Block: 9.1m				
MIN. SETBACKS	Camden DCP 2019 Part 4.6 MDH	Side Setback		Ground floor: 0.9m Upper floor: 4m		4m Eastern Bdy 5.5m Western Bdy		
	Table 4-7	Rear Setback		Ground floor: 4m Upper floor: 6m		13.5m (ground) 12m (1st floor)		
COMMUNAL LIVING AREA	Housing Cl. 25(SEPP 1)(f)	1 Cc	mmunal living area re	quired			
	Housing Cl. 24(12m² per room in exc 2 rooms= 30m² + 12m Min. dimension 3m	² = total 42m ²	Min. din	2m² nension of – Complies	
COMMUNAL OPEN SPACE	Housing Cl. 24(Min. 20% of site area 20% x 1274 = 254.8m Min. dimension = 3n	12	Min. din	5m2 nension of – Complies	
LANDSCAPED AREA			Min dim	Min 30% of site 30% x 1274m² = 382 zm² Min dimension of landscaped area = 1.5m Min. 40% of front setback to be landscaped 40% x front setback area m² = 124m² 189 m			nension = 5m	
DEEP SOIL				No specified minimu	m	38	8 m²	
SOLAR ACCESS	Housing Cl. 24(.	; SEPP 2)(e)	3 hours betw	reen 9am & 3pm 21 Ju communal living are		CLA recei direct sol	nplies ves 3 hours ar access – nplies	




GROUND FLOOR PLAN

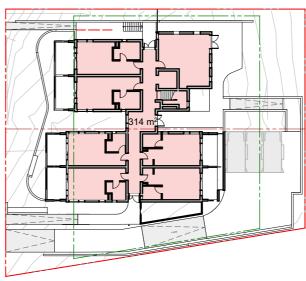


GROUND FLOOR PLAN

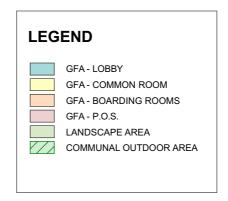

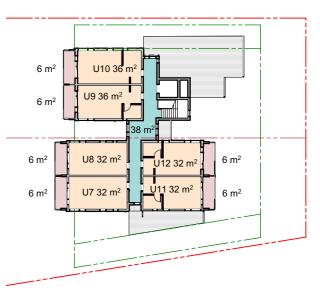

FIRST FLOOR PLAN

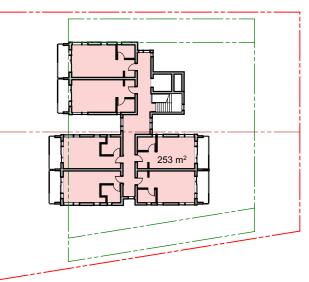

FIRST FLOOR PLAN





LOCKED BAG 5022 Part 5 submission
 REV
 APP'D
 DATE

 01
 SC
 8/12/2022
 PARRAMATTA NSW 2124 PHONE: 1800 738 718 WEBSITE: https://www.dpie.nsw.gov.au/

Min. 70% of living rooms & private opens spaces receive a min 3hrs direct sunlight between 9am-3pm mid-winter

8/12 units comply

samcrawfordarchitects

TELEPHONE +612 9519 6800 cts.com.au WEB samcrawfordarchitects.com.au LAND & HOUSING CORPORATION (LAHC)

CAMDEN BOARDING HOUSE

3-5 KELLOWAY AVENUE CAMDEN NSW 2570 - DHARAWAL COUNTRY

LOT 17/ DP 219782 LOT 18/ DP 219782


SCALE @ A3 PROJECT NO. 1:500 | BGX6L


A104 01


DEVELOPMENT DATA





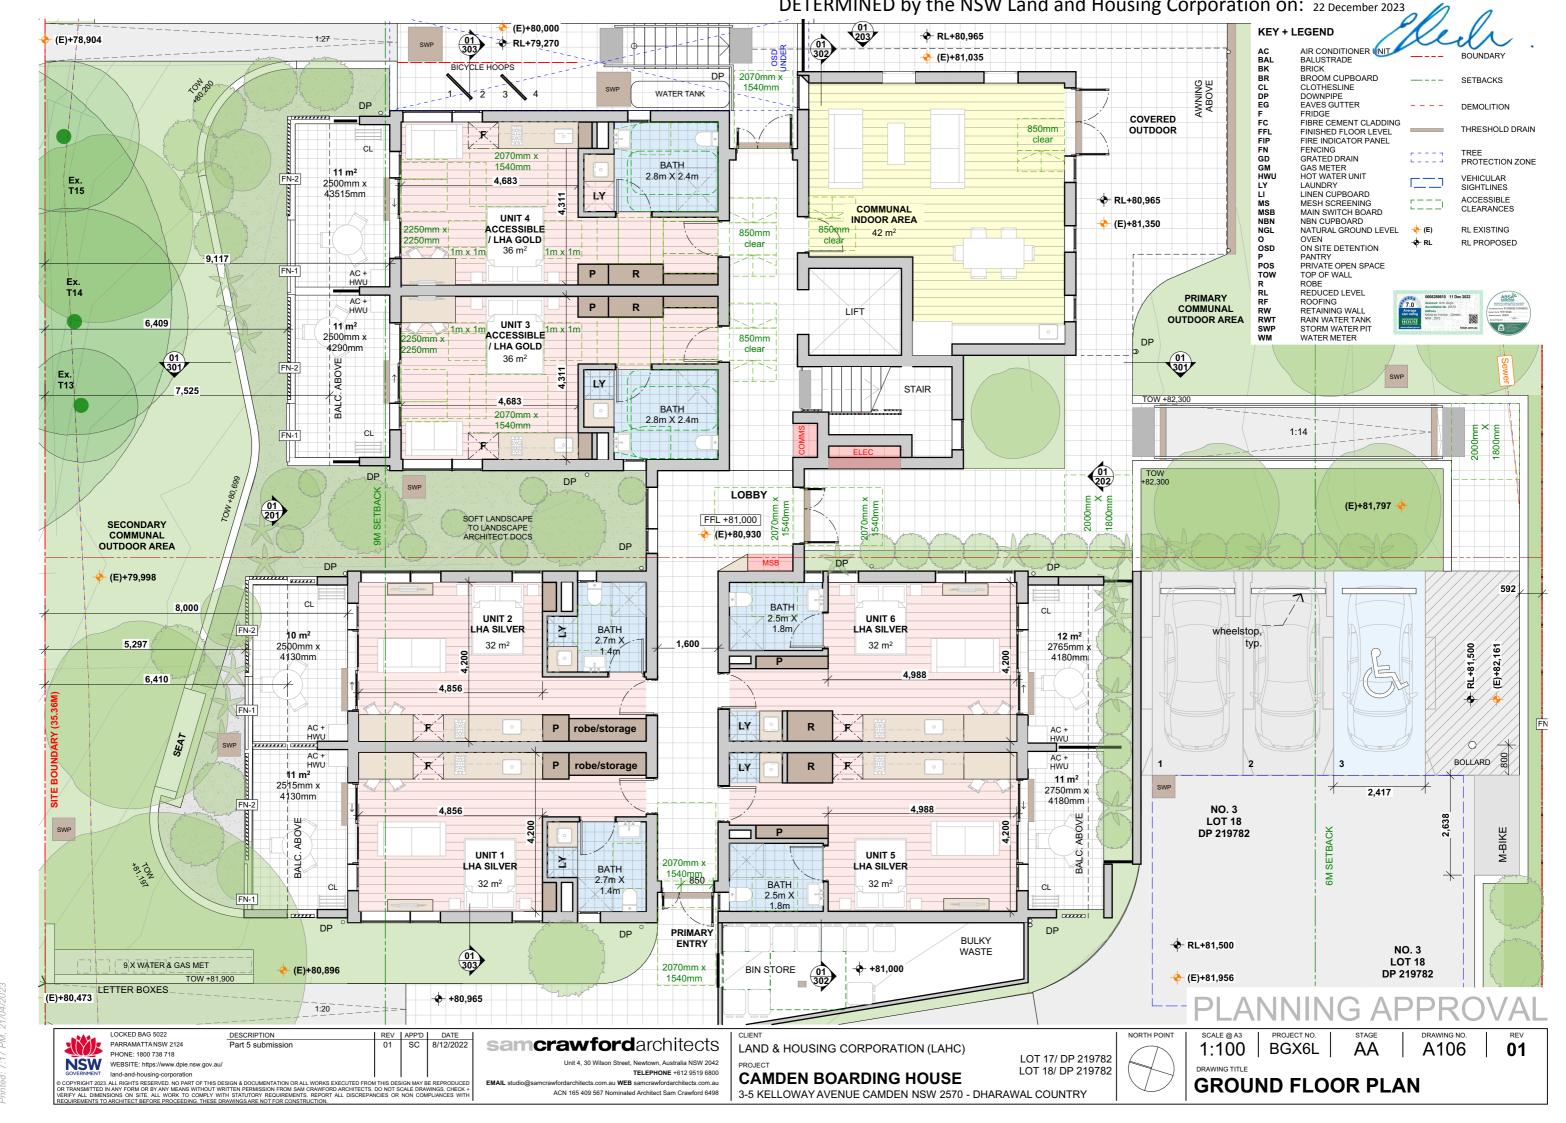

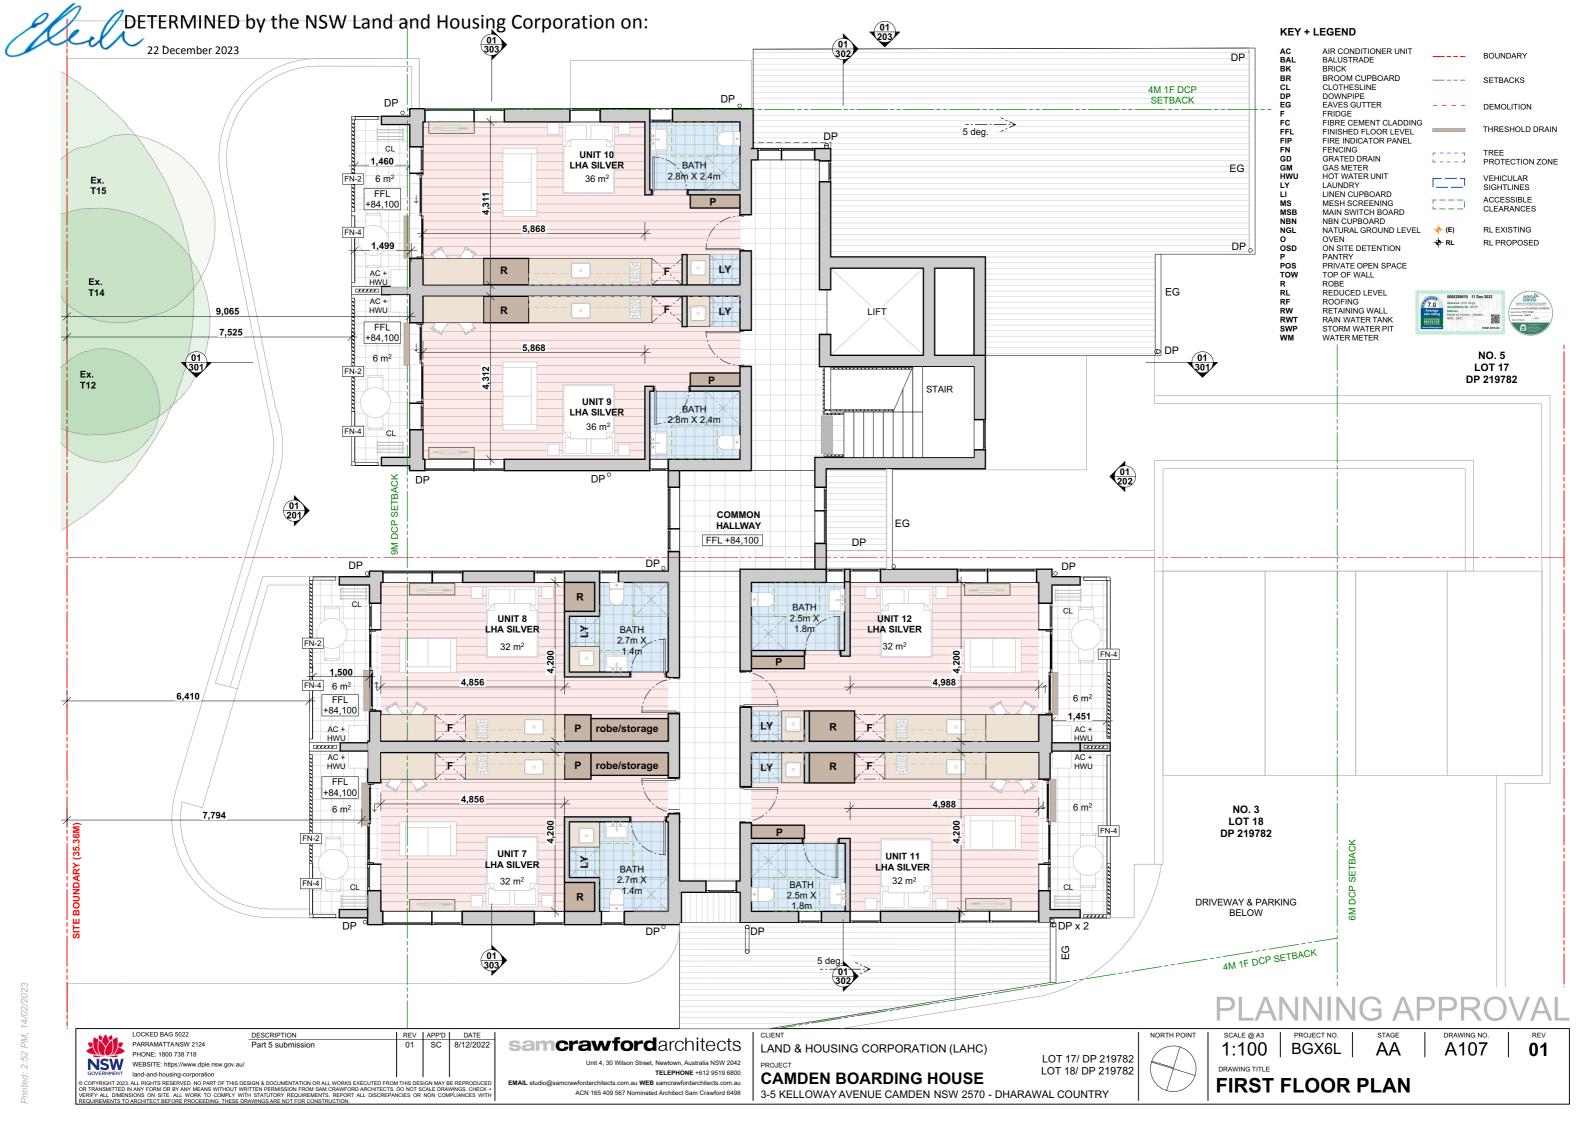

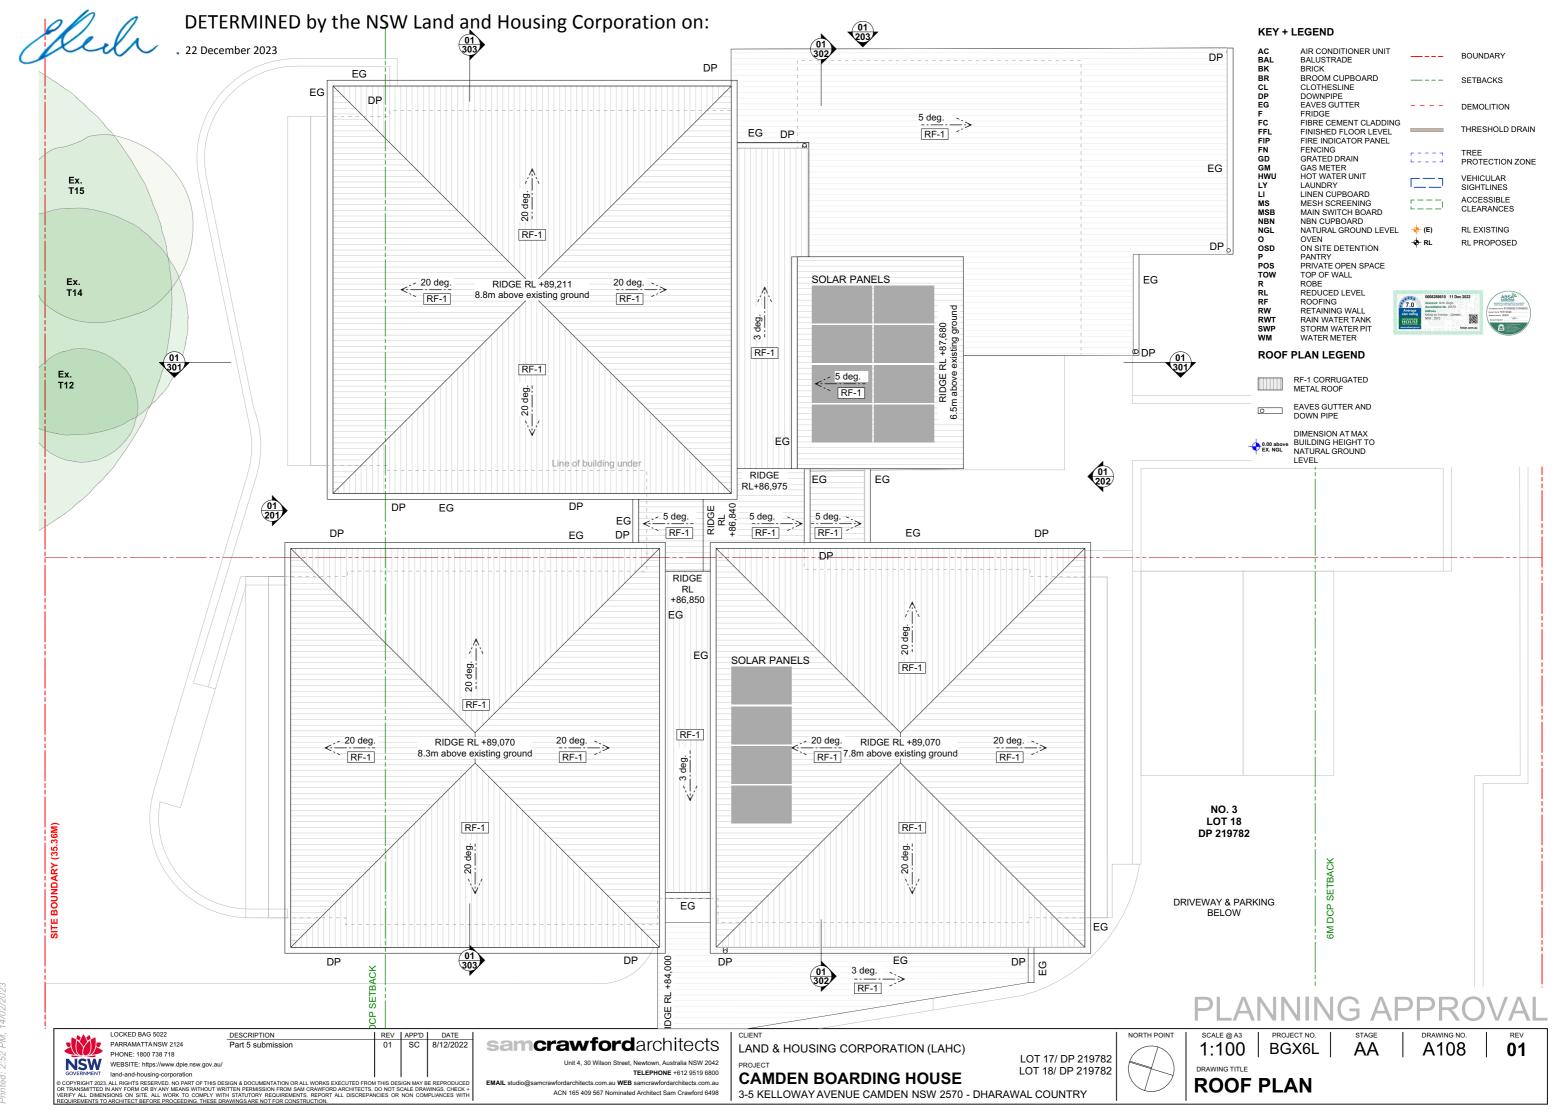






EXTERNAL FINISHES

BAL-01	BALUSTRADE METAL BALUSTRADE IN SHALE GREY	FC-02	SCREEN FIBRE CEMENT CLADDING SHEET - PAINTED TO MATCH FC-01
BK-01	WALLS BRICK - PGH BRICKS SMOOTH BLACK & TAN	RF-01	ROOF CORRUGATED METAL ROOF- LYSAGHT CUSTOM ORB SHALE GREY
BK-02	WALLS BRICK - PGH BRICKS BOTANICALS JUNIPER	RW-01	WALLS RENDERED RETAINING WALLS
FC-01	WALLS FIBRE CEMENT CLADDING - JAMES HARDIE AXON CLADDING SMOOTH 133		



PLANNING APPROVAL

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	LOCKED BAG 5022	DESCRIPTION	REV	APP'D	DATE		CLIENT		NORTH POINT	SCALE @ A3	PROJECT NO.	STAGE	DRAWING NO.	REV
A C	PARRAMATTA NSW 2124	Part 5 submission	01	SC	8/12/2022	samcrawford architects	LAND & HOUSING CORPORATION (LAHC)			1:150	BGX6L	AA	A201	01
7	PHONE: 1800 738 718			1 1			, ,	LOT 17/ DP 219782		1.130	DONOL	\neg	AZU I	01
N:	WEBSITE: https://www.dpie.nsw.gov.a	u/		1 1		Unit 4, 30 Wilson Street, Newtown, Australia NSW 2042 TELEPHONE +612 9519 6800	PROJECT	LOT 18/ DP 219782		DRAWING TITLE				
@ CORVE	NMENT land-and-housing-corporation	DESIGN & DOCUMENTATION OF ALL WORKS EVECUTED EF	I OM THIS DE	I I	E DEDDOUICED	FMAIL studio@camcrawfordarchitects.com.au WER samcrawfordarchitects.com.au	CAMDEN BOARDING HOUSE	201 10/ 21 210/02		NODTI		TION /	CTDEET\	
OR TRANS	MITTED IN ANY FORM OR BY ANY MEANS WITHOUT	WRITTEN PERMISSION FROM SAM CRAWFORD ARCHITEC WITH STATUTORY REQUIREMENTS. REPORT ALL DISCRE	rs. Do not Pancies of	SCALE DRAV	VINGS. CHECK + PLIANCES WITH	ACN 165 409 567 Nominated Architect Sam Crawford 6498	3-5 KELLOWAY AVENUE CAMDEN NSW 2570 - DHARA	AWAL COUNTRY		NORII	7 ELEV <i>F</i>	(1) NOLLY	STREET)	

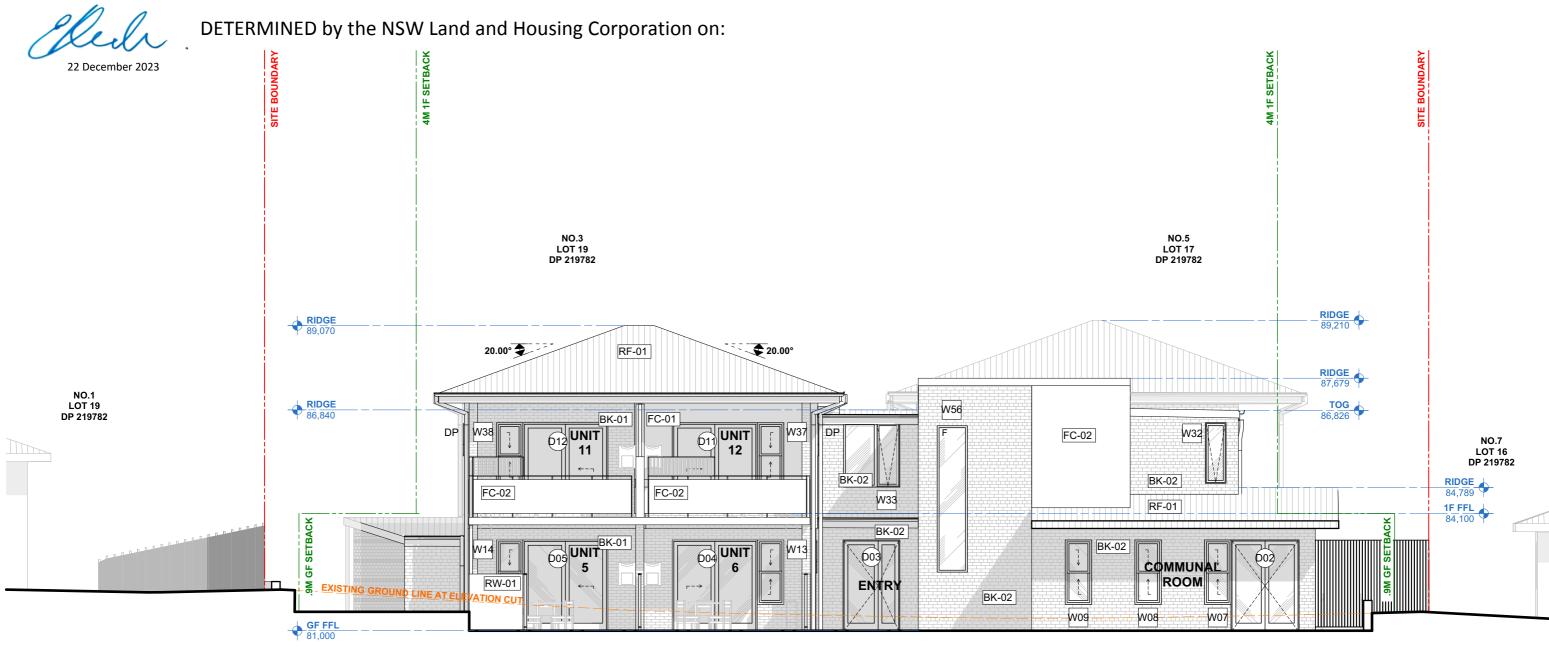

EXTERNAL FINISHES

BALUSTRADE BAL-01 METAL BALUSTRADE IN SHALE GREY WALLS BK-01 BRICK - PGH BRICKS SMOOTH BLACK & TAN **WALLS** BK-02 **BRICK - PGH BRICKS BOTANICALS JUNIPER** FIBRE CEMENT CLADDING - JAMES HARDIE FC-01 **AXON CLADDING SMOOTH 133** FIBRE CEMENT CLADDING SHEET - PAINTED FC-02 TO MATCH FC-01 **ROOF** RF-01 CORRUGATED METAL ROOF- LYSAGHT





CUSTOM ORB SHALE GREY

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RW-01

RENDERED RETAINING WALLS

LAND & HOUSING CORPORATION (LAHC)

CAMDEN BOARDING HOUSE

3-5 KELLOWAY AVENUE CAMDEN NSW 2570 - DHARAWAL COUNTRY

LOT 17/ DP 219782 LOT 18/ DP 219782

PROJECT NO. BGX6L 1:100


SCALE @ A3

AA

A202


01

SOUTH ELEVATION (REAR)

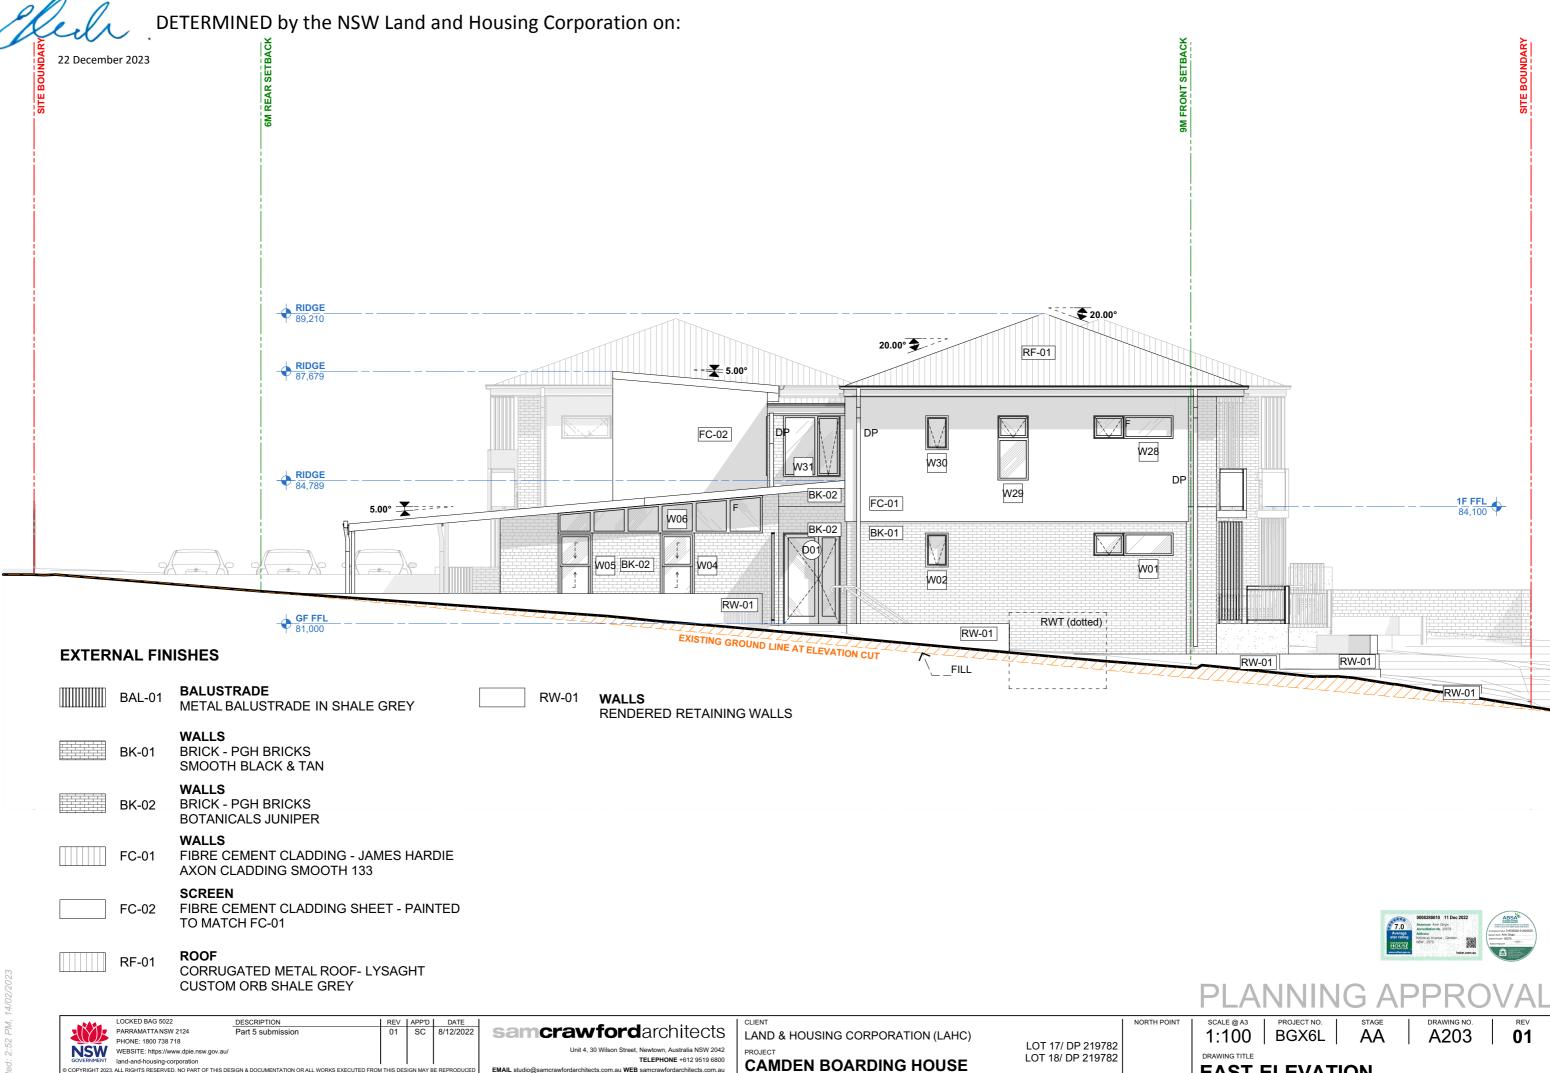

3-5 KELLOWAY AVENUE CAMDEN NSW 2570 - DHARAWAL COUNTRY

EAST ELEVATION

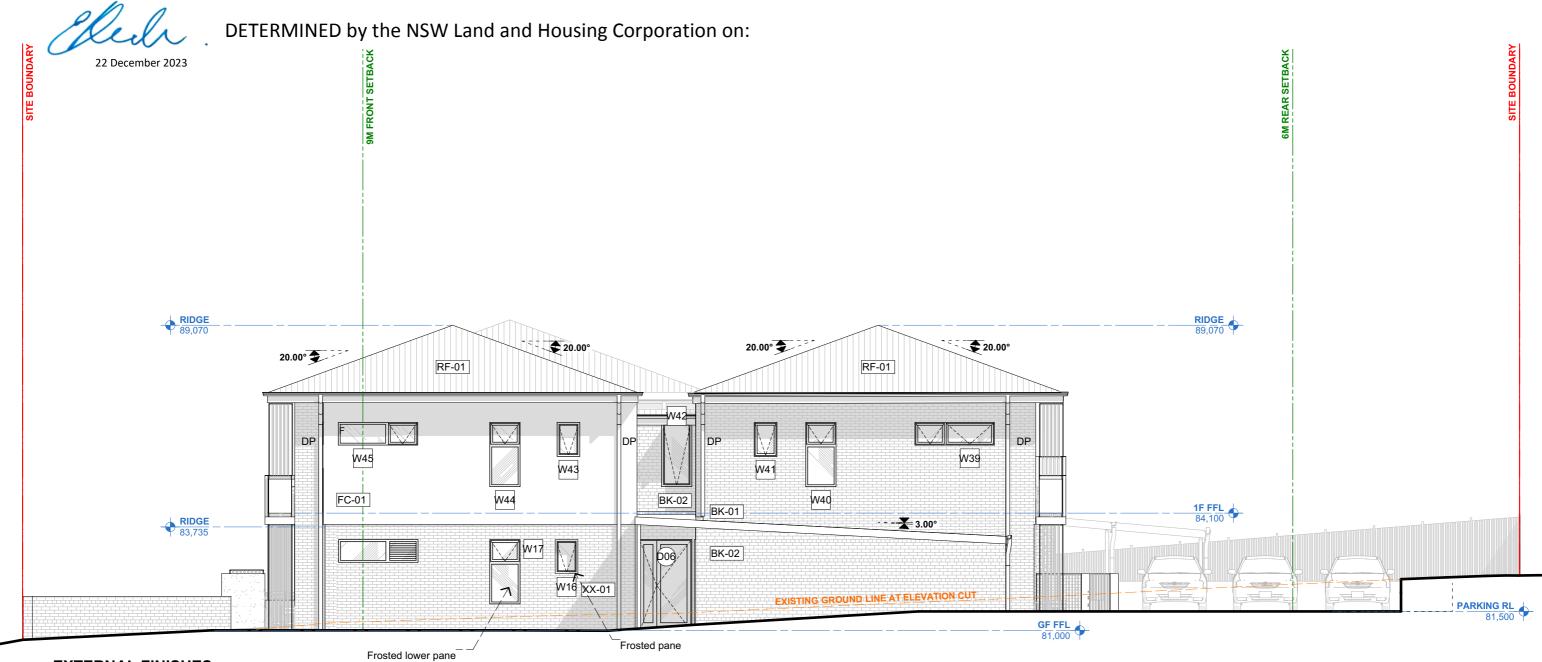

EXTERNAL FINISHES

BAL-01

METAL BALUSTRADE IN SHALE GREY WALLS BK-01 **BRICK - PGH BRICKS** SMOOTH BLACK & TAN WALLS BK-02 BRICK - PGH BRICKS **BOTANICALS JUNIPER** FIBRE CEMENT CLADDING - JAMES HARDIE FC-01 **AXON CLADDING SMOOTH 133**

BALUSTRADE

FIBRE CEMENT CLADDING SHEET - PAINTED FC-02 TO MATCH FC-01

ROOF RF-01

CORRUGATED METAL ROOF- LYSAGHT **CUSTOM ORB SHALE GREY**





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LOT 17/ DP 219782 LOT 18/ DP 219782 **CAMDEN BOARDING HOUSE** 3-5 KELLOWAY AVENUE CAMDEN NSW 2570 - DHARAWAL COUNTRY

SCALE @ A3 1:100


PROJECT NO. BGX6L

A204

01

WEST ELEVATION

DETERMINED by the NSW Land and Housing Corporation on:

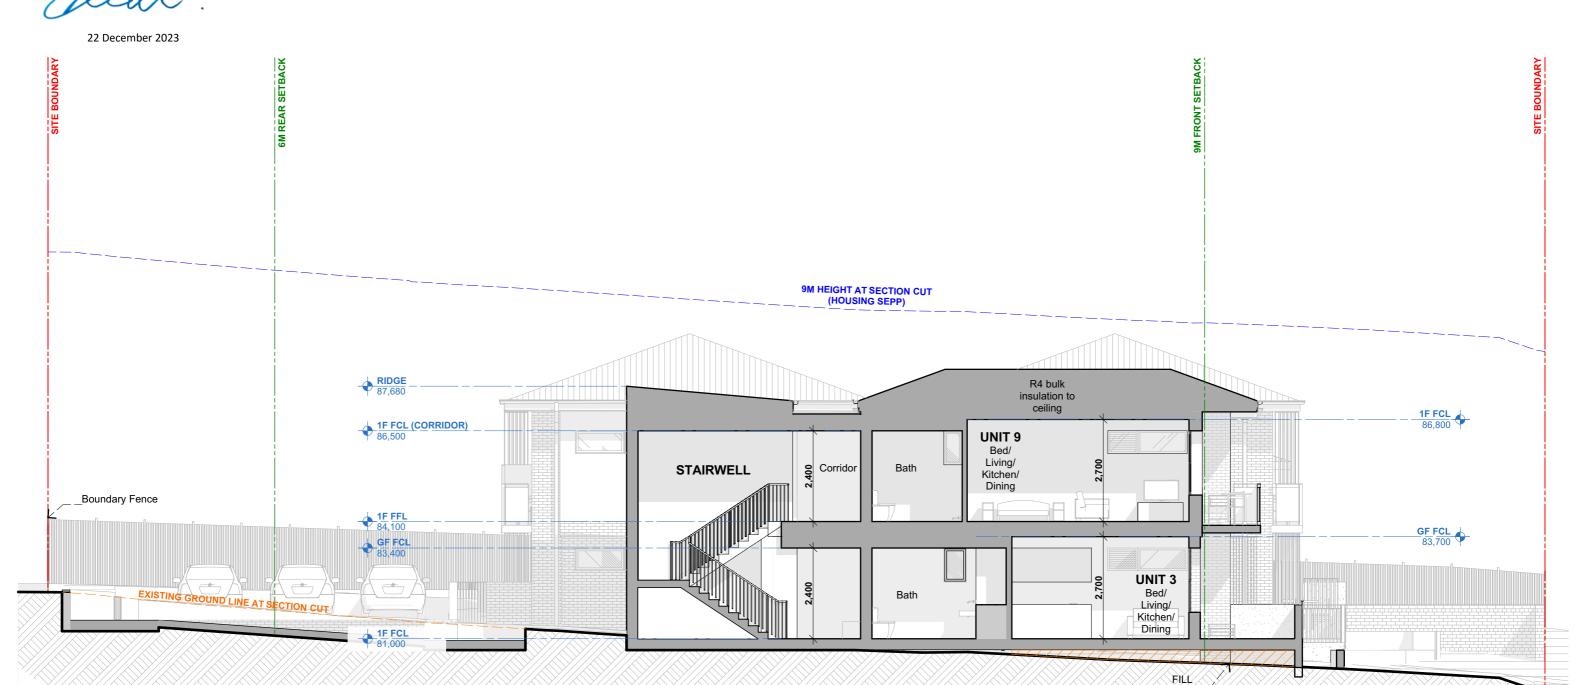





samcrawfordarchitects TELEPHONE +612 9519 6800

LAND & HOUSING CORPORATION (LAHC)

LOT 17/ DP 219782 LOT 18/ DP 219782

SCALE @ A3 1:100

PROJECT NO.

BGX6L


A301

01

CAMDEN BOARDING HOUSE

3-5 KELLOWAY AVENUE CAMDEN NSW 2570 - DHARAWAL COUNTRY

SECTION (LONG)

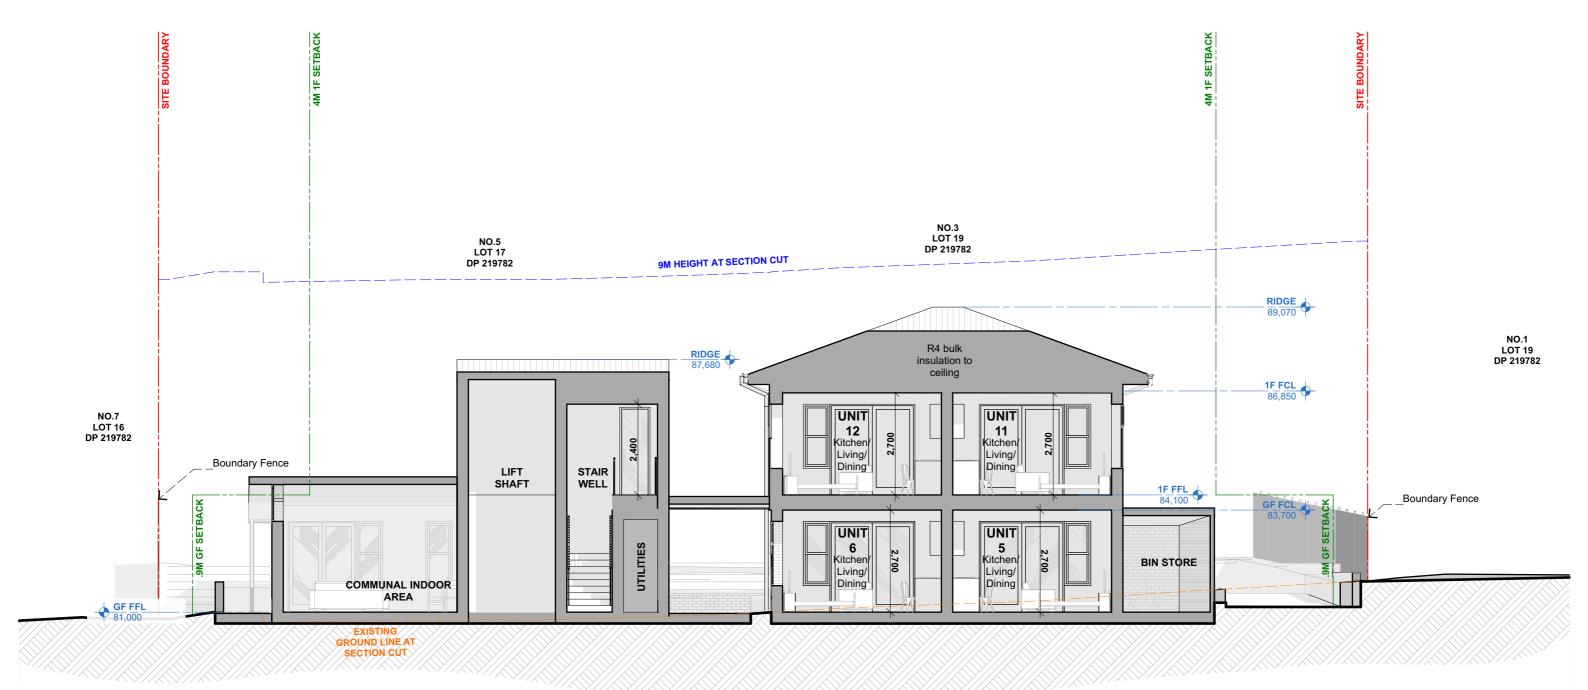





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LAND & HOUSING CORPORATION (LAHC)

LOT 17/ DP 219782 LOT 18/ DP 219782

PROJECT NO.

BGX6L SCALE @ A3 1:100

A302

01







PLANNING APPROVAL



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ACN 165 409 567 Nominated Architect Sam Crawford 6498

LAND & HOUSING CORPORATION (LAHC)

CAMDEN BOARDING HOUSE

3-5 KELLOWAY AVENUE CAMDEN NSW 2570 - DHARAWAL COUNTRY

LOT 17/ DP 219782 LOT 18/ DP 219782 SCALE @ A3 PROJECT NO.


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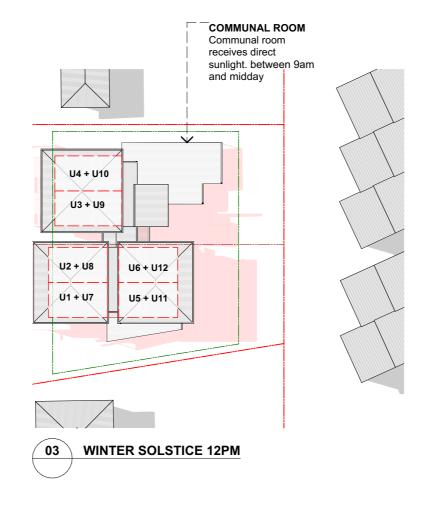
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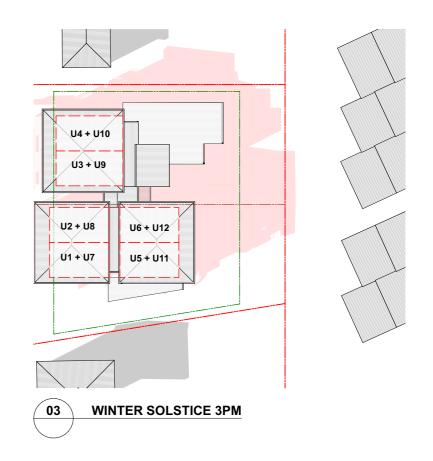
A303 REV 01


SECTION (CROSS 02)

SOLAR ACCESS REQUIREMENTS Req: 70% (9 units) to have a minimum of 3 hours of sunlight to the living spaces between 9am and 3pm on the winter solstice. UNIT COMPLIANT U1 U2 YES U4 NO YES U7 U8 YES YES U10 U11 NO U12





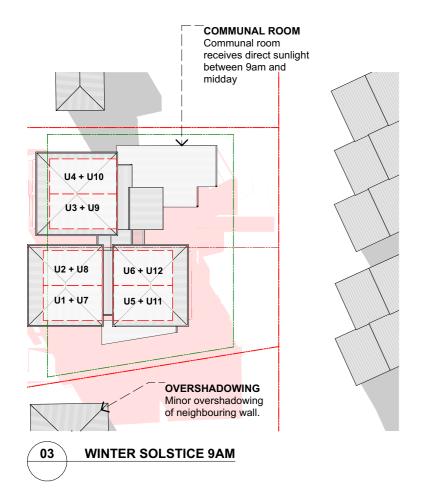

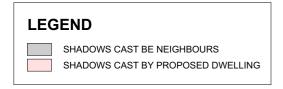







LAND & HOUSING CORPORATION (LAHC)

LOT 17/ DP 219782 LOT 18/ DP 219782



SCALE @ A3 PROJECT NO. BGX6L 1:500

A401 01

GOVERNMENT Indi-and-noising-corporation

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REQUIREMENTS TO ARCHITECT DEFORE PROCEDING. THESE DRAWINGS ARE NOT FOR CONSTRUCTION. TELEPHONE +612 9519 6800 **CAMDEN BOARDING HOUSE SHADOW DIAGRAMS** cts.com.au WEB samcrawfordarchitects.com.au ACN 165 409 567 Nominated Architect Sam Crawford 6498 3-5 KELLOWAY AVENUE CAMDEN NSW 2570 - DHARAWAL COUNTRY

DETERMINED by the NSW Land and Housing Corporation on:



UNIT 2: POS: YES LIVING: NO UNIT 7: POS: YES LIVING: YES UNIT 3: POS: YES LIVING: YES UNIT 8: POS: YES LIVING: YES UNIT 4: POS: YES LIVING: YES UNIT 9: POS: YES LIVING: NO UNIT 10: POS: YES LIVING: YES



UNIT 1: POS: YES LIVING: YES UNIT 7: POS: YES LIVING: YES UNIT 2: POS: YES LIVING: YES UNIT 8: POS: YES LIVING: YES UNIT 3: POS: YES LIVING: YES UNIT 9: POS: YES LIVING: YES UNIT 4: POS: YES LIVING: YES UNIT 10: POS: YES LIVING: YES



UNIT 1: POS: YES LIVING: YES UNIT 7: POS: YES LIVING: YES UNIT 2: POS: YES LIVING: YES UNIT 8: POS: YES LIVING: YES UNIT 3: POS: YES LIVING: YES UNIT 9: POS: YES LIVING: YES UNIT 4: POS: YES LIVING: YES UNIT 10: POS: YES LIVING: YES



UNIT 1: POS: YES LIVING: YES UNIT 7: POS: YES LIVING: YES UNIT 2: POS: YES LIVING: YES UNIT 8: POS: YES LIVING: YES UNIT 3: POS: YES LIVING: YES UNIT 9: POS: YES LIVING: YES UNIT 4: POS: YES LIVING: YES UNIT 10: POS: YES LIVING: YES



UNIT 1: POS: YES LIVING: YES UNIT 7: POS: YES LIVING: YES UNIT 2: POS: YES LIVING: YES UNIT 8: POS: YES LIVING: YES UNIT 3: POS: YES LIVING: YES UNIT 9: POS: YES LIVING: YES UNIT 4: POS: YES LIVING: YES UNIT 10: POS: YES LIVING: YES



UNIT 1: POS: YES LIVING: YES UNIT 7: POS: YES LIVING: YES UNIT 2: POS: YES LIVING: YES UNIT 8: POS: YES LIVING: YES UNIT 3: POS: YES LIVING: YES UNIT 9: POS: YES LIVING: YES UNIT 4: POS: YES LIVING: YES UNIT 10: POS: YES LIVING: YES



UNIT 1: POS: YES LIVING: YES UNIT 7: POS: YES LIVING: YES UNIT 2: POS: YES LIVING: YES UNIT 8: POS: YES LIVING: YES UNIT 3: POS: YES LIVING: YES UNIT 9: POS: YES LIVING: YES UNIT 4: POS: YES LIVING: YES UNIT 10: POS: YES LIVING: YES


SENIORS LIVING URBAN DESIGN GUIDE OBJECTIVE 5

UNIT 1: 3HR minimum (9AM-3PM) Midwinter POS: YES LIVING: YES UNIT 2: 3HR minimum (9AM-3PM) Midwinter POS: YES LIVING: YES UNIT 3: 3HR minimum (9AM-3PM) Midwinter POS: YES LIVING: YES UNIT 4: 3HR minimum (9AM-3PM) Midwinter POS: YES LIVING: YES UNIT 5: Not assessed from this angle. UNIT 6: Not assessed from this angle. UNIT 7: 3HR minimum (9AM-3PM) Midwinter POS: YES LIVING: YES

UNIT 8: 3HR minimum (9AM-3PM) Midwinter POS: YES LIVING: YES UNIT 9: 3HR minimum (9AM-3PM) Midwinter POS: YES LIVING: YES UNIT 10: 3HR minimum (9AM-3PM) Midwinter POS: YES LIVING: YES

UNIT 11: Not assessed from this angle. UNIT 12: Not assessed from this angle.

TOTAL COMPLYING: 8 OUT OF 12 UNITS

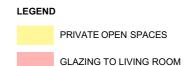





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m.au WEB samcrawfordarchitects.com.au

LAND & HOUSING CORPORATION (LAHC)

CAMDEN BOARDING HOUSE

LOT 18/ DP 219782 3-5 KELLOWAY AVENUE CAMDEN NSW 2570 - DHARAWAL COUNTRY

LOT 17/ DP 219782

SCALE @ A3 N.T.S.

BGX6L

A402

SOLAR DIAGRAMS NORTH WEST



UNIT 1: POS: YES LIVING: NO UNIT 7: POS: YES LIVING: YES UNIT 2: POS: YES LIVING: NO UNIT 8: POS: YES LIVING: YES UNIT 3: POS: YES LIVING: YES UNIT 9: POS: YES LIVING: NO UNIT 4: POS: YES LIVING: YES UNIT 10: POS: YES LIVING: YES



UNIT 1: POS: YES LIVING: YES UNIT 7: POS: YES LIVING: YES UNIT 2: POS: YES LIVING: YES UNIT 8: POS: YES LIVING: YES UNIT 3: POS: YES LIVING: YES UNIT 9: POS: YES LIVING: YES UNIT 4: POS: YES LIVING: YES UNIT 10: POS: YES LIVING: YES




UNIT 1: POS: YES LIVING: YES UNIT 7: POS: YES LIVING: YES UNIT 2: POS: YES LIVING: YES UNIT 8: POS: YES LIVING: YES UNIT 3: POS: YES LIVING: YES UNIT 9: POS: YES LIVING: YES UNIT 4: POS: YES LIVING: YES UNIT 10: POS: YES LIVING: YES



UNIT 1: POS: YES LIVING: YES UNIT 7: POS: YES LIVING: YES UNIT 2: POS: YES LIVING: YES UNIT 8: POS: YES LIVING: YES UNIT 3: POS: YES LIVING: YES UNIT 9: POS: YES LIVING: YES UNIT 4: POS: YES LIVING: YES UNIT 10: POS: YES LIVING: YES



UNIT 1: POS: YES LIVING: YES UNIT 7: POS: YES LIVING: YES UNIT 2: POS: YES LIVING: YES UNIT 8: POS: YES LIVING: YES UNIT 3: POS: YES LIVING: YES UNIT 9: POS: YES LIVING: YES UNIT 4: POS: YES LIVING: YES UNIT 10: POS: YES LIVING: YES

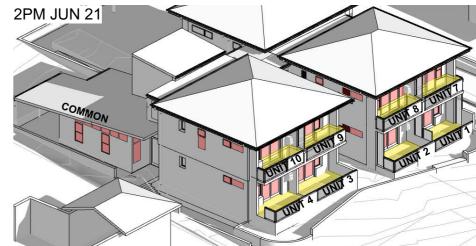

UNIT 1: POS: YES LIVING: YES UNIT 7: POS: YES LIVING: YES UNIT 2: POS: YES LIVING: YES UNIT 8: POS: YES LIVING: YES UNIT 3: POS: YES LIVING: YES UNIT 9: POS: YES LIVING: YES UNIT 4: POS: YES LIVING: YES UNIT 10: POS: YES LIVING: YES



UNIT 1: POS: YES LIVING: YES UNIT 7: POS: YES LIVING: YES UNIT 2: POS: YES LIVING: YES UNIT 8: POS: YES LIVING: YES UNIT 3: POS: YES LIVING: YES UNIT 9: POS: YES LIVING: YES UNIT 4: POS: YES LIVING: YES UNIT 10: POS: YES LIVING: YES

SENIORS LIVING URBAN DESIGN GUIDE OBJECTIVE 5

UNIT 1: 3HR minimum (9AM-3PM) Midwinter POS: YES
UNIT 2: 3HR minimum (9AM-3PM) Midwinter POS: YES
UNIT 3: 3HR minimum (9AM-3PM) Midwinter POS: YES
UNIT 4: 3HR minimum (9AM-3PM) Midwinter POS: YES
UNIT 4: 3HR minimum (9AM-3PM) Midwinter POS: YES
UNIT 5


UNIT 5: <u>Not assessed from this angle.</u>
UNIT 6: Not assessed from this angle.

UNIT 7: 3HR minimum (9AM-3PM) Midwinter POS: YES
UNIT 8: 3HR minimum (9AM-3PM) Midwinter POS: YES
UNIT 9: 3HR minimum (9AM-3PM) Midwinter POS: YES
UNIT 10: 3HR minimum (9AM-3PM) Midwinter POS: YES
UNIT 10: 3HR minimum (9AM-3PM) Midwinter POS: YES
LIVING: YES

UNIT 11: <u>Not assessed from this angle.</u>
UNIT 12: Not assessed from this angle.

COMMON: 3HR minimum (9AM-3PM) Midwinter Y/N: YES

TOTAL COMPLYING: 8 OUT OF 12 UNITS

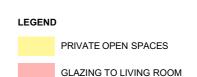



PLANNING APPROVAL



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LAND & HOUSING CORPORATION (LAHC)
PROJECT

CAMDEN BOARDING HOUSE

3-5 KELLOWAY AVENUE CAMDEN NSW 2570 - DHARAWAL COUNTRY


LOT 17/ DP 219782 LOT 18/ DP 219782 NORTH POINT

N.T.S. | PROJECT NO. BGX6L

AA

DRAWING NO. A403

SOLAR DIAGRAMS NORTH EAST

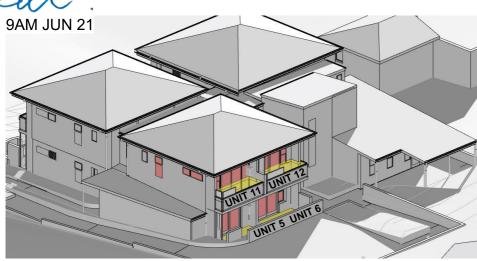


LIVING: NO UNIT 5: POS: NO UNIT 6: POS: NO LIVING: NO UNIT 11: POS: NO LIVING: NO UNIT 12: POS: NO LIVING: NO



UNIT 6: POS: NO LIVING: NO UNIT 11: POS: NO LIVING: NO UNIT 12: POS: NO LIVING: NO




LIVING: NO UNIT 5: POS: NO UNIT 6: POS: NO LIVING: NO UNIT 11: POS: NO LIVING: YES UNIT 12: POS: NO LIVING: NO

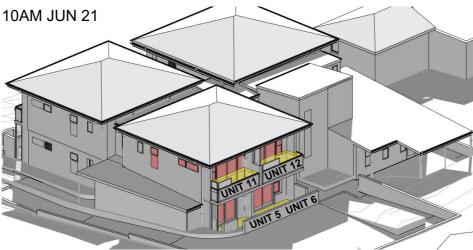

UNIT 5: POS: NO LIVING: NO UNIT 6: POS: NO LIVING: NO UNIT 11: POS: NO LIVING: NO UNIT 12: POS: NO LIVING: NO



LIVING: NO UNIT 5: POS: NO UNIT 6: POS: NO LIVING: NO UNIT 11: POS: NO LIVING: NO UNIT 12: POS: NO LIVING: NO

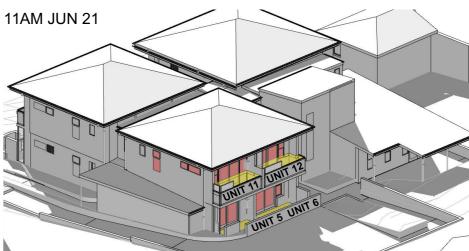

UNIT 5: POS: NO LIVING: NO UNIT 6: POS: NO LIVING: NO UNIT 11: POS: NO LIVING: NO UNIT 12: POS: NO LIVING: NO



LIVING: NO UNIT 5: POS: NO UNIT 6: POS: NO LIVING: NO UNIT 11: POS: NO LIVING: NO UNIT 12: POS: NO LIVING: NO

SENIORS LIVING URBAN DESIGN GUIDE OBJECTIVE 5

UNIT 1: Not assessed from this angle. UNIT 2: Not assessed from this angle.

UNIT 3: Not assessed from this angle. UNIT 4: Not assessed from this angle.

UNIT 5: 3HR minimum (9AM-3PM) Midwinter POS: NO LIVING: NO UNIT 6: 3HR minimum (9AM-3PM) Midwinter POS: NO LIVING: NO

UNIT 7: Not assessed from this angle. UNIT 8: Not assessed from this angle. UNIT 9: Not assessed from this angle.

UNIT 10: Not assessed from this angle.

UNIT 11: 3HR minimum (9AM-3PM) Midwinter POS: NO LIVING: NO UNIT 12: 3HR minimum (9AM-3PM) Midwinter POS: NO LIVING: NO

TOTAL COMPLYING: 8 OUT OF 12 UNITS

LEGEND

PRIVATE OPEN SPACES







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LAND & HOUSING CORPORATION (LAHC)

CAMDEN BOARDING HOUSE

LOT 18/ DP 219782 3-5 KELLOWAY AVENUE CAMDEN NSW 2570 - DHARAWAL COUNTRY

LOT 17/ DP 219782

BGX6L N.T.S.

A404

SOLAR DIAGRAMS SOUTH WEST



UNIT 5: POS: NO
UNIT 6: POS: NO
UNIT 11: POS: NO
UNIT 12: POS: NO
UNIT 12: POS: NO
LIVING: NO
LIVING: NO



UNIT 5: POS: NO
UNIT 6: POS: NO
UNIT 11: POS: NO
UNIT 12: POS: NO
UNIT 12: POS: NO
LIVING: NO
LIVING: NO



UNIT 5: POS: NO
UNIT 6: POS: NO
UNIT 11: POS: NO
UNIT 12: POS: NO
LIVING: NO
LIVING: NO



UNIT 5: POS: NO LIVING: NO UNIT 6: POS: NO LIVING: NO UNIT 11: POS: NO LIVING: NO UNIT 12: POS: NO LIVING: NO



UNIT 5: POS: NO
UNIT 6: POS: NO
UNIT 11: POS: NO
UNIT 12: POS: NO
LIVING: NO
UNIT 12: POS: NO
LIVING: NO



UNIT 5: POS: NO
UNIT 6: POS: NO
UNIT 11: POS: NO
UNIT 12: POS: NO
UNIT 12: POS: NO
LIVING: NO



UNIT 5: POS: NO
UNIT 6: POS: NO
UNIT 11: POS: NO
UNIT 12: POS: NO
UNIT 12: POS: NO
LIVING: NO

SENIORS LIVING URBAN DESIGN GUIDE OBJECTIVE 5

UNIT 1: Not assessed from this angle.
UNIT 2: Not assessed from this angle.

UNIT 2: Not assessed from this angle.
UNIT 3: Not assessed from this angle.
UNIT 4: Not assessed from this angle.

UNIT 5: 3HR minimum (9AM-3PM) Midwinter POS: NO LIVING: NO UNIT 6: 3HR minimum (9AM-3PM) Midwinter POS: NO LIVING: NO

UNIT 7: Not assessed from this angle.
 UNIT 8: Not assessed from this angle.
 UNIT 9: Not assessed from this angle.

UNIT 10: Not assessed from this angle.

UNIT 11: 3HR minimum (9AM-3PM) Midwinter POS: NO LIVING: NO UNIT 12: 3HR minimum (9AM-3PM) Midwinter POS: NO LIVING: NO

TOTAL COMPLYING: 8 OUT OF 12 UNITS

LEGEND

PRIVATE OPEN SPACES





PLANNING APPROVAL



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LAND & HOUSING CORPORATION (LAHC)

CAMDEN BOARDING HOUSE

3-5 KELLOWAY AVENUE CAMDEN NSW 2570 - DHARAWAL COUNTRY

LOT 17/ DP 219782 LOT 18/ DP 219782

NORTH POINT

N.T.S. | PROJECT NO. BGX6L

STAGE

A405

SOLAR DIAGRAMS SOUTH EAST





Metal Balustrade in 'Shale Grey'



Lysaght custom orb 0.48 BMT in 'Shale Grey'. Steel Columns, Fascia, Gutter, Downpipe to be in 'Shale Grey'



BK-01

PGH Smooth - Black & Tan



James Hardie Axon Cladding -Smooth 133



BK-02

PGH Botanicals - Juniper



FC sheeting painted to match FC-01



Concrete Blockwork Retaining Wall with rendered finish





BK-02 BK-01 FC-01 FC-01 RW-01 FC-01 BAL-01 RF-01 FC-02 FC-02

02 Communal indoor/outdoor

LOCKED BAG 5022 DESCRIPTION
Part 5 submission PARRAMATTA NSW 2124
PHONE: 1800 738 718 PHONE: 1800 738 718 NSW WEBSITE: https://www.dpie.nsw.gov.au/

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LAND & HOUSING CORPORATION (LAHC)

CAMDEN BOARDING HOUSE

໌01ີ

LOT 17/ DP 219782 LOT 18/ DP 219782

SCALE @ A3

PROJECT NO. BGX6L N.T.S.

A501

01

MATERIAL SCHEDULE

cts.com.au WEB samcrawfordarchitects.com.au ACN 165 409 567 Nominated Architect Sam Crawford 6498

3-5 KELLOWAY AVENUE CAMDEN NSW 2570 - DHARAWAL COUNTRY

Street perspective 2











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CLIENT LAND & HOUSING CORPORATION (LAHC)

LOT 17/ DP 219782 LOT 18/ DP 219782 **CAMDEN BOARDING HOUSE** 3-5 KELLOWAY AVENUE CAMDEN NSW 2570 - DHARAWAL COUNTRY

	NORTH POINT	
2		
2		

N.T.S. | PROJECT NO. BGX6L

A601



place design group.





LAHC CAMDEN BOARDING HOUSE 100% DESIGN DEVELOPMENT PACKAGE 3-5 KELLOWAY AVENUE, CAMDEN (LOT 17 AND 18, DP 219782)

Prepared for

NSW LAND AND HOUSING CORPORATION

MARCH 2023



Australia South East Asia

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Report title	3-5 Kelloway Avenue Camden NSW 2570
Document number	2520051
Prepared for	Sam Crawford Architects
Authors	Georgia McDonald, Caleb Wright
Revision number	02
Revision issue date	March 2023
Approved	Nick Ison
Reason for revision	Final Issue

Disclaimer: This report has been prepared in accordance with the scope of services described in the contract or agreement between Place Design Group Pty Ltd ACN 082 370063 and the Client. The report relies upon data, surveys, measurements and results taken at or under the particular times and conditions specified herein. Any findings, conclusions or recommendations only apply to the aforementioned circumstances and no greater reliance should be assumed or drawn by the Client. Furthermore, the report has been prepared solely for use by the Client and Place Design Group accepts no responsibility for its use by other parties.

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Landscape Plan	04
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Material Selection	06
Landscape Key Plan and Sections	07
Planting Schedule	08
Typical Landscape Details	09

EXTENT OF WORK







Extent of works




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LANDSCAPE PLAN








FENCING STRATEGY AND MATERIALS SCHEDULE

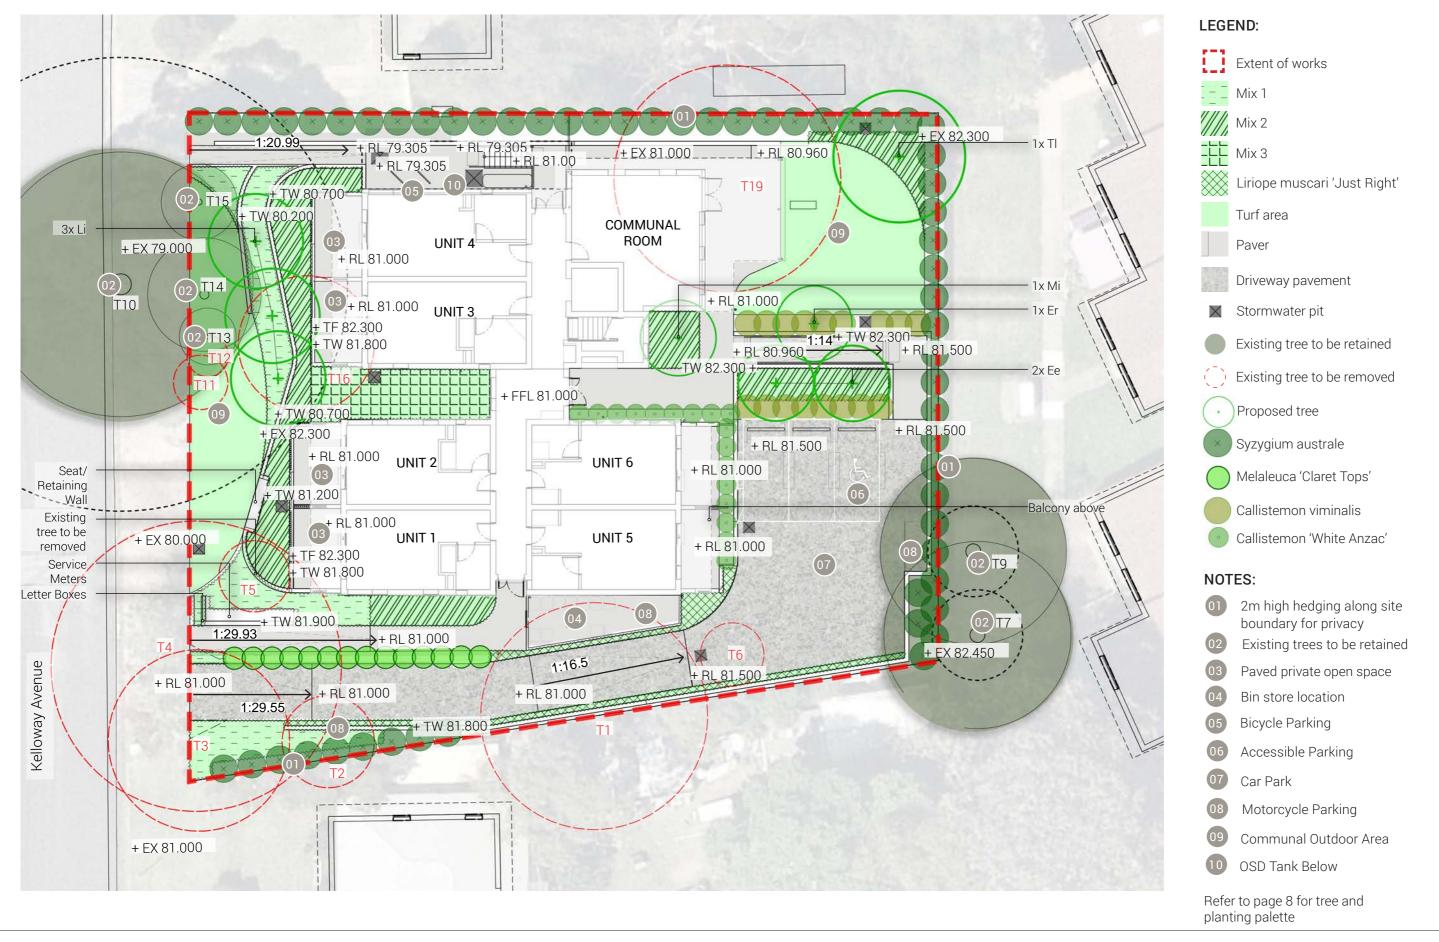

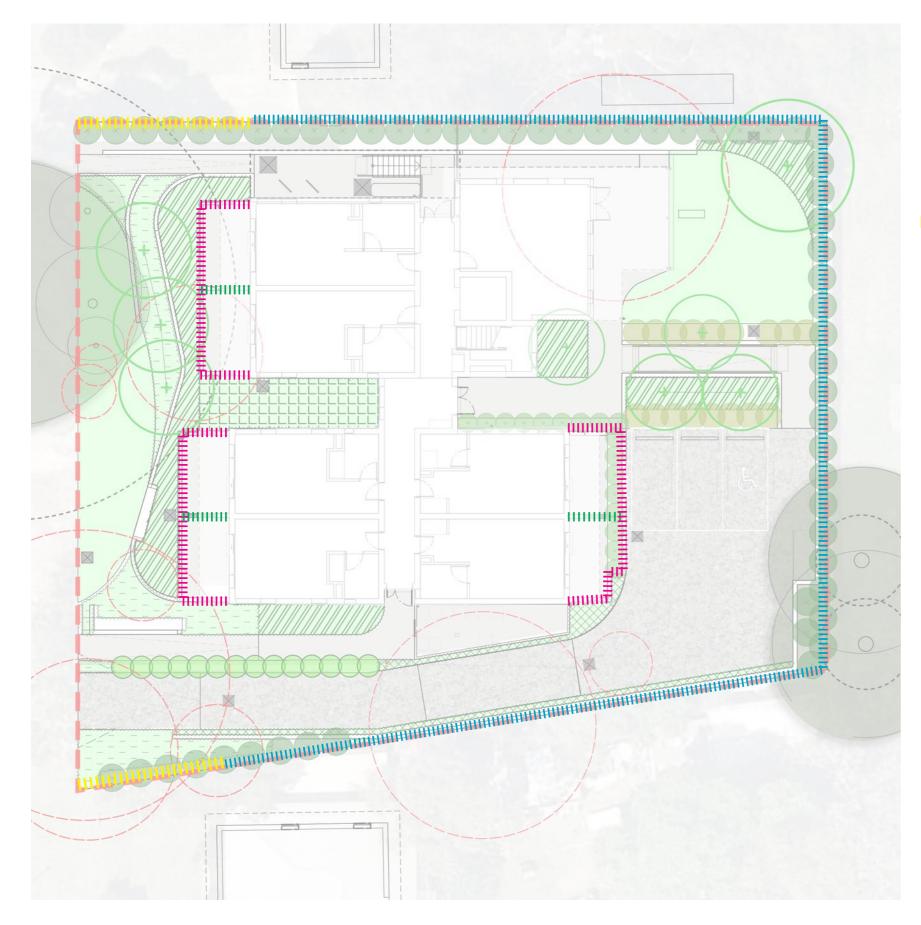

LEGEND:

Fence Type 1: Colorbond fence (1800mm)

Fence Type 2: Aluminium palisade fence on wall (500mm)

|||||||||||| Fence Type 3: Aluminium palisade fence (800mm)


Fence Type 4: Aluminium slat fence on wall (500mm)





LAHC_PETERS AVENUE SELECTION SCHEDULE					
DESCRIPTION	DIMENSIONS	SPECIFICATION	IMAGE		
FIXTURES AND FURNI	TURE				
FENCE TYPE 1	H: 1800mm	Description: Trimclad Colorbond steel fence Panel dimension: 2365mm L X 1800mm H Color: Monument grey Fixing: Refer to manufacture recommendation			
FENCE TYPE 2	H: 500mm	Description: Vertica steel slate fence panel on brick retaining wall Dimension: 500mm high Fixing: Refer to manufacture recommendation Colour: TBC+A9:E12			
FENCE TYPE 3	H: 800mm	Description: Vertica steel slate fence panel Dimension: 800mm high Fixing: Refer to manufacture recommendation Colour: TBC+A9:E12			
FENCE TYPE 4	H: 500mm	Description: Steel slat fence on brick retaining wall Dimension: 500mm H Color: Monument grey Fixing: Refer to manufacture recommendation			

LANDSCAPE KEY PLAN AND SECTIONS



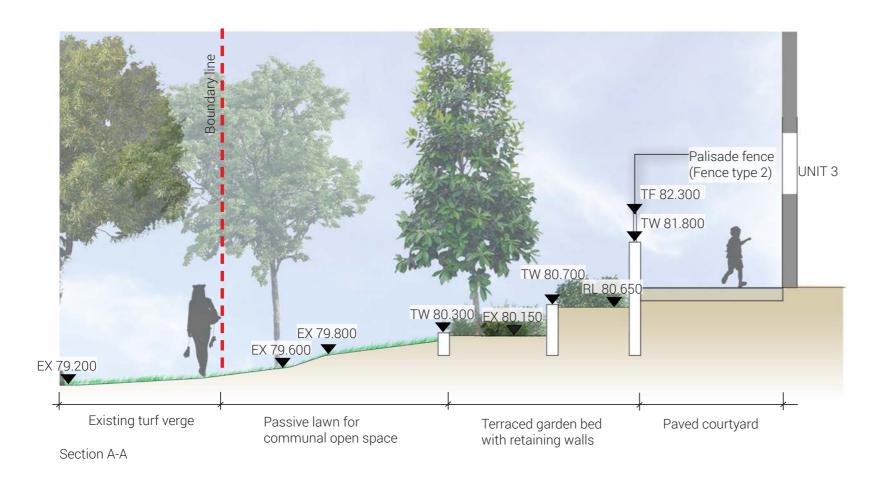

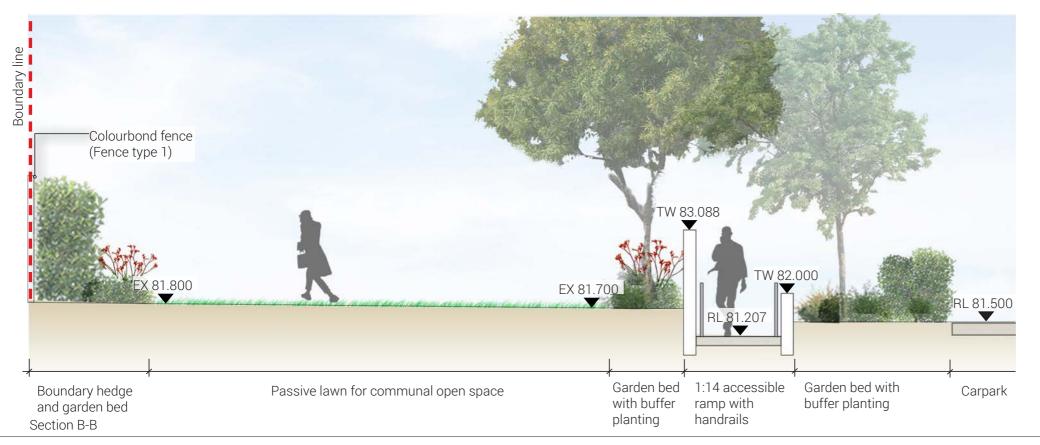

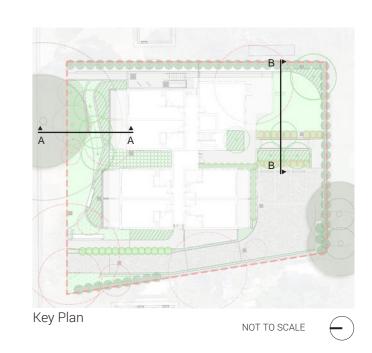




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PLANTING SCHEDULE

	LAHC CA	AMDEN PLANTING SCHEDUL	.E			
SYM	Botanical Name	Common Name	Mature Height	Pot Size	Spacing /m2	Quantity
TREES		•				
Ee	Elaeocarpus eumundi	Eumundi Quandong	10m	100L	As shown	2
r	Elaeocarpus reticulatus	Ash Quandong	10m	100L	As shown	1
_i	Lagerstroemia indica x fauriei 'Tuscarora'	Crepe Myrtle	6m	100L	As shown	3
Mi	Malus ioensis 'Plena'	Flowering Crab Apple	5m	100L	As shown	1
Π	Tristaniopsis laurina 'Luscious'	Water Gum	12m	100L	As shown	1
SHRU				<u> </u>		
Cv	Callistemon viminalis 'Captain Cook'	Weeping Bottlebrush	1.8m	150mm	As shown	17
Cwa	Callistemon 'White Anzac'	Bottlebrush 'White Anzac'	1m	150mm	As shown	17
VICT.	Melaleuca 'Claret Tops'	Honey Myrtle	1m	150mm	As shown	14
Μр	Myoporum parvifolium	Boobialla	0.2m	150mm	1.5/linm	230
Sa	Syzygium australe	Brush Cherry	2m	200mm	As shown	57
Mix 1						
Clj	Callistemon 'Little John'	Bottlebrush 'Little John'	0.8m	150mm	6	71
3t	Gazania tomentosa	Silver Leaf Gazania	0.2m	150mm	8	47
_m	Liriope muscari 'Just Right'	Lilyturf	0.5m	150mm	6	71
_	Lomandra longifolia 'Tanikia'	Mat Rush	0.6m	150mm	6	71
Dd	Ozothamnus diosmifolius 'Coral Flush'	Rice Flower	1m	150mm	6	53
⊃bb	Phormium 'Bronze Baby'	Dwarf New Zealand Flax	0.6m	150mm	6	53
VIix 2						
Эс	Dianella caerulea	Blue Flax-lily	1m	150mm	4	91
)e	Doryanthes excelsa	Gymea Lily	2m	200mm	2	24
_m	Liriope muscari 'Just Right'	Just Right	0.5m	150mm	6	136
Ир	Myoporum parvifolium	Boobialla	0.2m	150mm	8	97
Pр	Pandorea pandorana 'Flat White'	Wonga Wonga Vine	0.3m	150mm	8	97
Mix 3						
Ae	Aspidistra elatior	Cast Iron Plant	1.2m	150mm	4	31
Cm	Clivia miniata	Bush Lily	0.6m	150mm	6	39
Osf	Dichondra 'Sliver Falls'	Dichondra	0.0m	150mm	8	31
Мр	Viola hederacea	Native Violet	0.2m	150mm	8	21
λίh	Philodendron xanadu	Xanadu	1m	150mm	6	31
DRIVE	WAY PLANTING					
_m	Liriope muscari 'Just Right'	Just Right	0.5m	150mm	6	102
TURF						
OM	Kakadu	Kakadu	N/A	N/A	N/A	N/A
				, , , , ,	,	.,

TREES





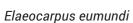

Elaeocarpus reticulatus



Tristaniopsis laurina 'Luscious'



Lagerstroemia indica x Malus ioensis 'Plena' fauriei 'Tuscarora'



DETERMINED by the NSW Land and Housing Corporation on:

Shrubs - Hedging & Screening



Syzygium australe



Melaleuca 'Claret Tops'



Callistemon 'White Anzac'



Callistemon viminalis



Myoporum parvifolium

MIX 1 - Planting to entry



Liriope muscari 'Just



Lomandra 'Tanika'



Ozothamnus diosmifolius Gazania tomentosa 'Coral Flush'



Phormium 'Bronze Baby



Callistemon 'Little John'

MIX 2 - Medium and low planting



Liriope muscari 'Just Right'



Pandorea pandorana 'Flat White'



Dianella caerulea



Doryanthes excelsa



Myoporum parvifolium

MIX 3 - Shade Tolerant Planting



Aspidistra elatior



Clivia miniata



Dichondra 'Sliver Falls'

DATE



Myoporum parvifolium




Philodendron xanadu









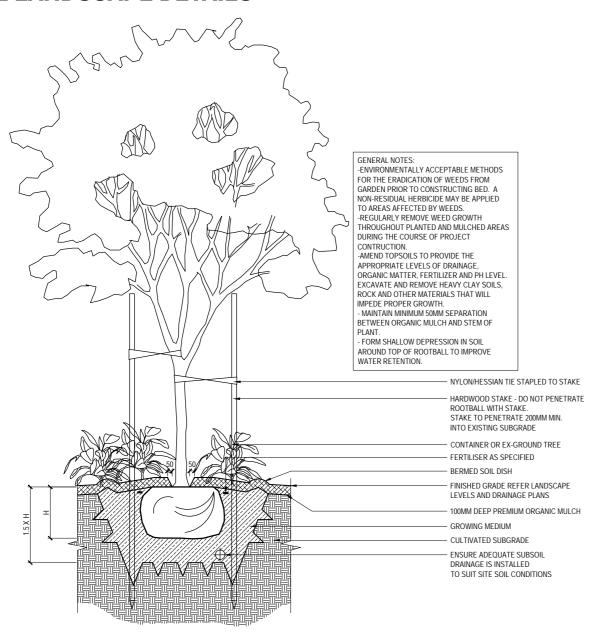


Detail 1: Tree Planting 1:40 @A3

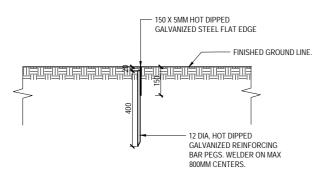


Detail 2: Steel Edge Detail 1:20 @A3

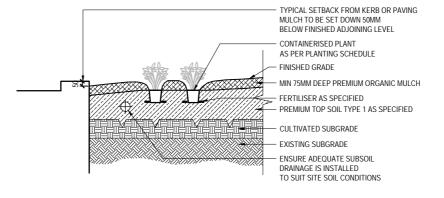

Detail 3: Mass Planting Detail 1:40 @A3

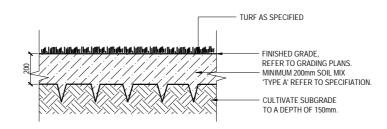

Detail 4: Typical Turf Detail 1:20 @A3

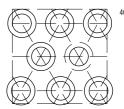

400MM SPACING ON CENTRES

Mass Planting Layout Detail 1:40@A3



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07/106/2023	2520051	02	9



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SAM CRAWFORD ARCHITECT

CAMDEN BOARDING HOUSE LOT 17/DP 219782 LOT 18/DP 219782 3-5 KELLOWAY AVENUE, CAMDEN, 2570 NSW

COVER SHEET, LOCALITY PLAN AND SCHEDULE OF DRAWINGS

SCHEDULE OF DRAWINGS					
DRAWING No. DESCRIPTION					
	GENERAL				
80822228-CI-0001	COVER SHEET, LOCALITY PLAN AND SCHEDULE OF DRAWINGS				
80822228-CI-0002	CIVIL CONSTRUCTION NOTES				
	PLANS AND SCHEDULES				
80822228-CI-0101	PROPOSED DRAINAGE STORMWATER PLAN				
80822228-CI-0111	CUT AND FILL PLAN				
80822228-CI-0121	SEDIMENTATION AND EROSION CONTROL PLAN				
	STANDARD DETAILS				
80822228-CI-0201	STORMWATER STANDARD DETAILS SHEET 1				
80822228-CI-0202	STORMWATER STANDARD DETAILS SHEET 2				
80822228-CI-0221	SEDIMENTATION AND EROSION CONTROL DETAILS				





LOCALITY PLAN NOT TO SCALE

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) File:	1	20/05/2022	PRELIMINARY ISSUE	K.P.	C.F.	C.F.	
CAD	Rev.	Date	Description	Des.	Verif.	Appd.	

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ACN 165 409 567 Nominated Architect Sam Crawford 6498

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G.M.	APRIL 2022	
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Verified	Date	
C.F.	APRIL 2022	
Approved		

Status	
FOR APPROVAL NOT TO BE USED FOR CONSTRUCTION PURI	POSI

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Drawing Number				Revision		
80822228-CI		I-0001		3		

GENERAL NOTES

- G1. THESE DRAWINGS SHALL BE READ IN CONJUNCTION WITH ALL ARCHITECTURAL AND OTHER CONSULTANTS DRAWINGS AND SPECIFICATIONS AND WITH SUCH OTHER WRITTEN INSTRUCTIONS THAT MAY BE ISSUED DURING THE COURSE OF THE CONTRACT. ANY DISCREPANCIES IN THESE DOCUMENTS SHALL BE REFERRED TO THE SUPERINTENDENT FOR A DECISION BEFORE PROCEEDING WITH THE
- G2. THE CONTRACTOR SHALL CHECK AND BE RESPONSIBLE FOR THE CORRECTNESS OF ALL DIMENSIONS AND ANY DISCREPANCY SHALL BE REPORTED IMMEDIATELY TO THE SUPERINTENDENT. DIMENSIONS SHALL NOT BE OBTAINED BY SCALING FROM THE DRAWINGS.
- G3. STABILITY OF THE BUILDING DURING CONSTRUCTION AND EXCAVATION IN THE VICINITY OF ADJACENT BUILDINGS SHALL BE THE RESPONSIBILITY OF THE CONTRACTOR. NO PART OF THE STRUCTURE SHALL BE OVER STRESSED. APPROVAL OF ALL PROPOSALS MUST BE GRANTED BY THE ARCHITECT PRIOR TO THE COMMENCEMENT OF WORK.
- G4. THE CONTRACTOR SHALL NOTIFY THE ENGINEER FORTY EIGHT (48) HOURS BEFORE THE REINFORCEMENT IS COMPLETED. THE CONTRACTOR SHALL ALLOW TWO (2) HOURS AFTER THE COMPLETION OF THE REINFORCEMENT FOR THE ENGINEER'S INSPECTION. CONCRETE SHALL NOT BE ORDERED UNTIL THE REINFORCEMENT IS APPROVED BY THE ENGINEER
- G5. ALL WORKMANSHIP AND MATERIALS SHALL BE IN ACCORDANCE WITH THE REQUIREMENTS OF THE CURRENT SAA CODES, THE BY-LAWS AND ORDINANCES OF THE RELEVANT BUILDING AUTHORITY AND THE SPECIFICATION.
- G6. NO CHANGES SHALL BE MADE WITHOUT THE WRITTEN CONSENT OF THE ENGINEER.
- G7. U.N.O. DENOTES UNLESS NOTED OTHERWISE ON THE DRAWINGS.
- G8. ALL PROPRIETARY PRODUCTS AND APPROVED EQUIVALENTS NOTED ON THE DRAWINGS SHALL BE SUPPLIED AND INSTALLED IN STRICT ACCORDANCE WITH THE MANUFACTURER'S SPECIFICATIONS.

SITE PREPARATION

ROAD WORKS

- SP1. REMOVE TOP SOIL, ROOT AFFECTED SOIL, FILL AND OTHER DELETERIOUS MATERIAL TO EXPOSE NATURAL SUBGRADE.
- SP2. THE EXPOSED SUBGRADE SHOULD THEN BE PROOF ROLLED WITH AT LEAST EIGHT (8) PASSES OF A 10 TONNE MIN. DEAD WEIGHT ROLLER. ANY SOFT OR HEAVING AREAS SHOULD BE REMOVED TO A MAXIMUM DEPTH OF 300mm AND REPLACED WITH CLEAN WELL GRADED MATERIAL SUCH AS RIPPED OR CRUSHED SANDSTONE COMPACTED TO AT LEAST 100% OF STANDARD MAXIMUM DRY DENSITY (SMDD) AT ±2% OPTIMUM MOISTURE CONTENT IN ACCORDANCE WITH AS1289.
- SP3. COMPACTED FILL SHOULD BE PLACED IN LAYERS NOT EXCEEDING 150mm THICK AND COMPACTED TO AT LEAST 100% SMDD. FILL SHALL CONSIST OF CLEAN WELL GRADED MATERIAL SUCH AS RIPPED OR CRUSHED SANDSTONE WITH A MIN. CBR
- SP4. DENSITY TESTING SHALL BE CARRIED OUT TO LEVEL 2 CERTIFICATION IN ACCORDANCE WITH AS3798.
- SP5. SUB-BASE COURSE TO BE DGS20 OR DGS40 OR RIPPED OR CRUSHED SANDSTONE WITH A CBR GREATER THAN 40%, MAXIMUM PARTICLE SIZE OF 60mm, WELL GRADED WITH A PLASTIC INDEX LESS THAN 10. COMPACT TO AN AVERAGE OF NOT LESS THAN 100% SMDD WITH A MINIMUM VALUE OF 98% SMDD.
- SP6. ALL KERBS TO BE FORMED BY KERB MACHINE AND NOT BY HAND. EXTERNAL FOOTPATHS/PAVEMENTS
- SP7. REMOVE TOP SOIL, ROOT AFFECTED SOIL, FILL AND OTHER DELETERIOUS MATERIAL TO EXPOSE NATURAL SUBGRADE.
- SP8. THE EXPOSED SUBGRADE SHOULD BE PROOF ROLLED. ANY SOFT OR HEAVING AREAS SHOULD BE REPLACED WITH CLEAN WELL GRADED MATERIAL. FILL IF REQUIRED, SHOULD BE CLEAN AND WELL GRADED. COMPACT TO 100% SMDD.

STORMWATER CONSTRUCTION NOTES

- SW1. ESTABLISH EXACT LOCATION AND INVERT OF EXISTING SERVICES PRIOR TO COMMENCING WORKS.
- SW2. ALLOW TO PAY ALL LOCAL AUTHORITY FEES AS REQUIRED FOR PERIODIC INSPECTIONS/APPROVALS.
- SW3. ALL WORK TO BE IN ACCORDANCE WITH THE LOCAL COUNCIL STORMWATER POLICY.
- SW4. MINOR FLOW ARI = 20 YEARS MAJOR FLOW ARI = 100 YEARS

- SW5. ALL WORKS TO COMPLY TO AS3500
- SW6. ALL NEW PIPES 300 DIA. & LARGER SHALL BE REINFORCED CONCRETE CLASS 2 WITH RUBBER RING JOINTS, WHERE ANGLED THE MINIMUM RADIUS SHALL BE 152m. 150/225mm DIA. STORMWATER PIPES SHALL BE SEWER CLASS UPVC. MINIMUM PIPE SIZE FOR AN UNDERGROUND PIPE TO BE 150mm. MINIMUM PIPE
- SW7. ALL DRAINAGE TRENCHES SHALL BE IN SOUND EXCAVATED MATERIAL. IF SOFT SPOTS EXIST, REMOVE AND BACKFILL WITH COMPACTED ROAD BASE (DGS40) WITH A MINIMUM CBR OF 25 COMPACT TO 98% STANDARD MAXIMUM DRY DENSITY TO AS
- SW8. ALL PIPES SHALL BE BEDDED ON 100mm SAND BED AND BACKFILLED WITH SAND TO 150mm ABOVE BARREL OF PIPE. THE REMAINDER OF THE TRENCH WILL BE BACKFILLED IN 150mm COMPACTED LAYERS IN GRANULAR FILL NON DISPERSIVE (EMERSON CLASS 5 OR 6) MATERIAL - NO TOP SOIL, GRASS, ROOTS, OR DELETERIOUS MATERIAL. COMPACT TO 98% STANDARD MAXIMUM DRY DENSITY AT ±2% OMC.
- SW9. PROVIDE A 100mm DIA. UPVC. SLOTTED DRAINAGE PIPE 3000 LONG WRAPPED IN FILTER FABRIC SOCK IN ALL TRENCHES ADJACENT TO INLET PIPES TO PITS & CONNECTED TO PIT.
- SW10. OTHER SUB SOIL DRAINAGE PIPES SHALL BE 100mm DIA. UPVC SLOTTED BEDDED AND BACKFILLED WITH 20mm GAUGE BLUE METAL. CLEAN OUTS SHALL BE EXTENDED TO THE SURFACE AND PROVIDED WITH A SCREWED COVER PLATE FLUSH WITH THE FINISHED SURFACE LEVEL.
- SW11 ALL CONCRETE PITS CONSTRUCTED SHALL BE BEDDED AS PER PIPE SPECIFICATION. PIT BASES SHALL BE SMOOTH CONTOURED WITH MASS CONCRETE BENCHING PROVIDE STEP IRONS AS PER PIT SCHEDULE, PROVIDE HEAVY, MEDIUM OR LIGHT DUTY GALVANISED GRATE COVERS AS SPECIFIED IN SCHEDULE. ALL DRAINAGE WORKS ARE TO BE COMPLETED TO THE SATISFACTION OF THE SUPERVISING CIVIL ENGINEER. ALL WORKS TO COMPLY TO AS3500. HEADWALLS SHALL BE PRECAST CONCRETE BY 'BCP PRECAST' OR EQUAL. ALL PITS SHALL BE PRECAST CONCRETE TYPE DPT FOR DEEP PITS BY ICON INDUSTRIES OR EQUAL. PRECAST DRAINAGE PITS DEEPER THAN 1800mm SHALL HAVE 150mm MIN. WALL THICKNESS. 20mm DIA. GALV. MS. STEP IRONS SHALL BE INSTALLED IN PITS 1200mm AND DEEPER.
- SW12 UNLESS NOTED OTHERWISE ON THE PLANS, PROVIDE THE FOLLOWING MIN. COVER
- UNDER LANDSCAPE & PAVEMENT 300mm - UNDER ROAD (TRAFFIC) - 600mm

SEDIMENT RUN-OFF CONTROL NOTES

- SR1. THE CONTRACTOR SHALL INSTALL AND MAINTAIN SOIL EROSION AND SEDIMENT CONTROL MEASURES GENERALLY IN ACCORDANCE WITH GUIDELINES OF THE LANDCOM MANAGING URBAN STORMWATER MANUAL AND AS NECESSARY TO PREVENT RUN-OFF FROM SITE OF SEDIMENT RESULTING FROM THE WORKS. SUCH MEASURES SHALL ALSO COMPLY WITH REQUIREMENTS OF COUNCIL, LANDCOM "BLUE BOOK" AND EPA. THIS WORK SHALL BE DONE PRIOR TO ANY EARTHWORKS COMMENCING ON SITE.
- SR2. GRADE FINISHED SURFACE TO SHED WATER EVENLY WITHOUT CHANNELLING (UNTIL PIPED STORMWATER SYSTEM IS CONSTRUCTED). NOMINAL GRADIENTS FROM HIGH POINT OF 0.2%.
- SR3. MAINTAIN THE EROSION CONTROL DEVICES INDICATED ON THE DRAWINGS TO THE SATISFACTION OF THE SITE SUPERINTENDENT AND THE LOCAL AUTHORITIES.
- SR4. WHEN PROPOSED STORMWATER PITS ARE CONSTRUCTED, PREVENT SITE RUNOFF ENTERING UNLESS SILT FENCES ARE ERECTED AROUND PITS AND ON ROAD.

TO BE MAINTAINED FOR THE DURATION OF THE CONTRACT.

SR5. STREET PROTECTION WITH SHAKER EXIT GRIDS & STREET PIT INLET PROTECTION

WARNING

UNLESS NOTIFIED TO THE CONTRARY IN WRITING, THE CONTRACTOR SHALL BE HELD RESPONSIBLE FOR ANY BREACHES OF THE PROTECTION OF ENVIRONMENT OPERATIONS ACT 1997. PLEASE NOTE FAILURE TO IMPLEMENT OR MAINTAIN APPROPRIATE EROSION/SEDIMENT CONTROL MEASURES IS A BREACH OF THE ACT. SUCH A BREACH IS LIABLE FOR A ON-THE SPOT FINE AND /OR PENALTY.

CONCRETE

- C1. ALL WORKMANSHIP AND MATERIALS SHALL BE IN ACCORDANCE WITH THE CURRENT SAA CODE AS3600, WITH AMENDMENTS, EXCEPT WHERE VARIED BY THE CONTRACT DOCUMENTS.
- C2. CONCRETE QUALITY:

ELEMENT	SLUMP (MAX)	MAX AGG. SIZE	CEMENT TYPE	ADMIX.	CONCRETE GRADE
CONCRETE DRIVEWAYS	60	20mm	А	N/A	40 MPa
CONCRETE KERBS, RETAINING WALLS	80	20mm	A	N/A	32 MPa
FOOTPATHS	80	20mm	Α	N/A	25 MPa
PIERS	80	20mm	Α	N/A	25 MPa

- SUSPENDED CONCRETE FLOORS:
- MIN. CEMENT CONTENT = 300 kg/m³
- MAX. PERMISSIBLE DRYING SHRINKAGE = 750 MICROSTRAIN AT 56 DAYS.
- C3. CLEAR CONCRETE COVER IN mm TO REINFORCEMENT U.N.O. SHALL BE AS FOLLOWS:-

		MENT COVER	ENT COVER		
STRUCTURAL ELEMENT	INTERNAL		EXTE	ERNAL	
	TOP	ВТМ.	TOP	BTM.	
FOOTINGS & PIERS	-	-	50	50	
DRAINAGE PITS			5	50	
CONCRETE DRIVEWAY			4	10	

- CONCRETE POURED OVER A MEMBRANE ON THE GROUND IS INCLUDED AS INTERNAL
- 2. CONCRETE EXPOSED TO CORROSIVE VAPOURS, CORROSIVE GROUND WATER, SEA WATER OR SPRAY IS TO HAVE REINFORCEMENT COVER AS NOTED ON THE DRAWINGS.
- 3. CONCRETE REQUIRING A FIRE RESISTANCE RATING SHALL HAVE REINFORCEMENT COVER AS NOTED ON THE DRAWINGS.
- EXTERNAL ABOVE GROUND ELEMENTS ARE CLASSIFIED IN NEAR COASTAL ENVIRONMENT. CONDUITS, PIPES, ETC., SHALL NOT BE PLACED IN THE CONCRETE COVER TO REINFORCEMENT AND NO HOLES OR CHASES OTHER THAN THOSE SHOWN ON THE STRUCTURAL DRAWINGS SHALL BE ALLOWED
- WITHOUT THE PRIOR APPROVAL OF THE SUPERINTENDENT. CONCRETE SIZES DO NOT INCLUDE THE THICKNESS OF APPLIED FINISHES.
- C6. THE DEPTH OF BEAMS IS GIVEN FIRST AND INCLUDES THE SLAB THICKNESS.
- CONSTRUCTION JOINTS, WHERE NOT SHOWN, SHALL BE LOCATED TO THE APPROVAL OF THE
- FORMWORK SHALL REMAIN IN POSITION FOR THE TIME SPECIFIED. WHERE SLABS AND BEAMS ARE TO SUPPORT MASONRY OVER, FORMWORK AND PROPS MUST BE REMOVED PRIOR TO THE CONSTRUCTION OF MASONRY.
- C9. ALL CONCRETE SHALL BE MECHANICALLY VIBRATED. THE VIBRATOR SHALL NOT BE USED TO SPREAD
- CONCRETE SHALL BE CURED IN ACCORDANCE WITH AS3600 WITH A PRODUCT COMPATIBLE WITH THE APPLIED FINISHES. CURING COMPOUNDS SHALL COMPLY WITH AS3799. PVA BASED CURING COMPOUNDS
- REINFORCEMENT IS REPRESENTED DIAGRAMMATICALLY, IT IS NOT NECESSARILY SHOWN IN TRUE PROJECTION.
- WELDING OF REINFORCEMENT SHALL NOT BE PERMITTED UNLESS SHOWN ON THE STRUCTURAL DRAWINGS.
- SPLICES IN THE MAIN REINFORCEMENT SHALL BE MADE ONLY IN THE POSITIONS SHOWN. SPLICES IN THE DISTRIBUTION REINFORCEMENT MAY BE POSITIONED AS NECESSARY WITH SPLICES OF SUFFICIENT LENGTH TO DEVELOP THE FULL STRENGTH OF THE BARS. MINIMUM LAPS TO FABRIC SHALL BE TO OVER LAP TWO CROSS WIRES PLUS 50mm U.N.O. REINFORCEMENT SHALL BE SECURELY TIED AT ALL LAPS AND INTERSECTIONS WITH 1.25mm BLACK ANNEALED WIRE. THE WRITTEN APPROVAL OF THE SUPERINTENDENT SHALL BE OBTAINED FOR OTHER SPLICES WHERE THE LAP LENGTH IS NOT SHOWN. IT SHALL DEVELOP THE FULL STRENGTH OF THE REINFORCEMENT.
- ALL UNSUPPORTED BARS SHALL BE TIED IN A TRANSVERSE DIRECTION WITH N12-300 U.N.O.
- REINFORCEMENT SHALL BE SUPPORTED ON APPROVED PLASTIC OR PLASTIC TIPPED WIRE STOOLS AT
- NOT MORE THAN 600mm CENTRES BOTHWAYS IN SLABS AND AT 1000mm CENTRES IN BEAMS. C16. DENOTES MAIN WIRES OF RECTANGULAR FABRIC TO AS4671. DENOTES SQUARE FABRIC TO AS4671
 - SL..... DENOTES GRADE 500 DEFORMED WIRE REINFORCING SQUARE FABRIC OF DUCTILITY CLASS L TO AS4671.
 - RL..... DENOTES GRADE 500 DEFORMED WIRE REINFORCING RECTANGULAR
 - FABRIC OF DUCTILITY CLASS L TO AS4671. R DENOTES GRADE 250 ROUND BARS OF DUCTILITY CLASS N TO
 - N DENOTES GRADE 500 DEFORMED BARS OF DUCTILITY CLASS N TO

 - S DENOTES GRADE 250 DEFORMED BARS OF DUCTILITY CLASS N TO

- C17. FABRIC SHALL BE SUPPLIED IN FLAT SHEETS, ROLLS WILL NOT BE ACCEPTED
- C18. TYPICAL REINFORCEMENT NOTATION:-

5N24-200 INDICATES

- 5 DENOTES NUMBER OF BARS REQUIRED
- N DENOTES GRADE OF REINFORCEMENT 24..... DENOTES BAR DIAMETER IN MILLIMETRES
- 200... DENOTES BAR SPACING IN MILLIMETRES
- TYPICAL ABBREVIATIONS:-
- B DENOTES BARS IN BOTTOM LAYER
- T DENOTES BARS IN TOP LAYER ALT.... DENOTES BARS ALTERNATING
- NF DENOTES BARS IN NEAR FACE
- FF DENOTES BARS IN FAR FACE
- EF DENOTES BARS IN EACH FACE C19. FOR SLAB FALLS, CHAMFERS, REGLETS, DRIP GROOVES, ETC., REFER TO THE ARCHITECT'S DRAWINGS.
- C20. LAP LENGTHS FOR DEFORMED BARS AS FOLLOWS:

BAR TYPE	VERTICAL	HORIZONTAL BARS WITH MORE THAN 300mm	OTHER	90° COG
AND SIZE	BARS	OF CONCRETE BELOW BAR	LOCATIONS	LENGTH
N12	500	550	500	200
N16	700	800	700	200
N20	1000	1250	1000	250
N24	1200	1500	1200	300
N28	1400	1750	1400	350

BLOCK RETAINING WALLS

- RW1. VERTICAL RODS FROM BASE ARE TO BE FIXED USING TEMPLATES TO ENSURE
- ACCURATE SPACING AND POSITIONING.
- RW2. CONCRETE BLOCKS TO BE GRADE 15 IN ACCORDANCE WITH AS/NZS4455.
- RW3. MORTAR 1:1:6 CEMENT:LIME:FINE AGGREGATE, SITE MIXED TO HAVE A COMPRESSIVE STRENGTH AT 12 DAYS OF 11 MPa.
- ALL HOLES TO BE CLEANED OF MORTAR AT END OF EACH DAY.
- RW5. GROUT: F'c = 20 MPa
 - SLUMP: = 230 MAXIMUM
- AGGREGATE: = 10mm.
- RW6. ALL CORE HOLES TO BE VIBRATED TO ENSURE COMPACTION, USING A DEFORMED RODDING BAR.
- RW7. FILL CORES TO 1500 MAX. HEIGHT IN ANY ONE POUR. STOP POUR 50 BELOW TOP OF
- BLOCK. FINAL LEVELS FLUSH WITH TOP OF BLOCK. RW8. PROVIDE EXPANSION JOINTS AS DETAILED.
- RW9. DO NOT BACKFILL UNTIL RESTRAINING SLAB OVER & BASEMENT SLAB HAVE BEEN CAST & CURED. BACKFILLING TO BE BLUEMETAL AS DETAILED, WITH PROVISION OF CORE DRAIN, REFER TO HYDRAULIC ENGINEER'S DETAILS FOR SUBSOIL DRAINAGE
- RW10. TANKING, SEALING AND DRAINAGE TO ARCHITECTS DETAILS. RW11. ALLOW FOR CLEAN-OUT BLOCKS AT BASE, IN ACCORDANCE WITH AS3700.

3	12/12/2022	DRAFT DA	G.M.	C.F.	C.F.
2	30/08/2022	70% DRAFT PART 5	G.M.	C.F.	C.F.
1	20/05/2022	PRELIMINARY ISSUE	K.P.	C.F.	C.F.
Rev.	Date	Description	Des.	Verif.	Appd.



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K.P.	APRIL 202
Designed	Da
K.P.	APRIL 202
Verified	Da
C.F.	APRIL 20
Approved	

ate 22	Client	SAM CRAWFORD ARCHITECT
ate 22 ate 22	Project	CAMDEN BOARDING HOUSE LOT 17/DP 219782 LOT 18/DP 219782
ate 22	Title	3-5 KELLOWAY AVENUE, CAMDEN, 2570 NSW CIVIL CONSTRUCTION NOTES

Status	FOR AP	PROVAL		
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AHD		N/A		A1
Drawing Number				Revision
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STORMWATER PIT SCHEDULE								
SWP No.	Pit Cover Level (RL)	Pit Invert Level (IL)	Depth (mm)	Internal Pit Size	Pit Type	Cover Type	Cover Class	Remarks
SWP-1	81.900	81.450	450	450x450	SIP	GRATE	А	
SWP-2	82.100	81.350	750	450x450	SIP	GRATE	Α	
SWP-3	81.500	81.050	450	450x450	SIP	SOLID	D	
SWP-4	81.500	80.950	550	450x450	SIP	GRATE	D	
SWP-5	81.000	80.500	500	600X600	SIP	GRATE	D	
SWP-6	80.400	79.900	500	600X600	SIP	GRATE	Α	
SWP-7	80.600	79.850	750	600X600	SIP	GRATE	А	
SWP-8	80.400	79.750	650	600X600	SIP	GRATE	А	
SWP-9	79.200	78.500	700	600X600	SIP	GRATE	А	
SWP-10	78.800	TBC	-	-	KIP	GRATE	А	EXISTING STORMWATER PIT1.8 m LINTEL

	GRATED DRAIN TYPE SCHEDULE						
LABEL	TYPE	MINIMUM INTERNAL DEPTH	INTERNAL WIDTH	GRATE LOAD CLASS	REMARK		
GD1	"S200K POWER DRAIN" BY ACO DRAIN OR SIMILAR APPROVED	200	200	D	HEELPROOF ANTI- SLIIP OR SIMILAR APPROVED		
GD2	"S200K POWER DRAIN" BY ACO DRAIN OR SIMILAR APPROVED	200	200	С	HEELPROOF ANTI- SLIIP OR SIMILAR APPROVED		
GD3	"S200K POWER DRAIN" BY ACO DRAIN OR SIMILAR APPROVED	200	200	В	HEELPROOF ANTI- SLIIP OR SIMILAR APPROVED		
GD4	"S200K POWER DRAIN" BY ACO DRAIN OR SIMILAR APPROVED	200	200	С	HEELPROOF ANTI- SLIIP OR SIMILAR APPROVED		

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ı	2	30/08/2022	70% DRAFT PART 5	G.M.	C.F.	C.F.
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Project CAMDEN BOARDING HOUSE
LOT 17/DP 219782 LOT 18/DP 219782
3-5 KELLOWAY AVENUE, CAMDEN, 2570 NSW


Title PROPOSED DRAINAGE STORMWATER
PITS AND GRATED DRAINS
SCHEDULE


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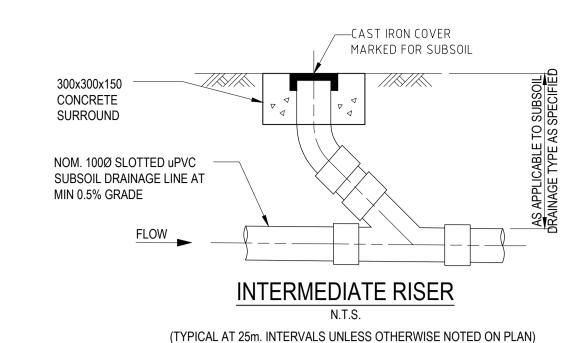
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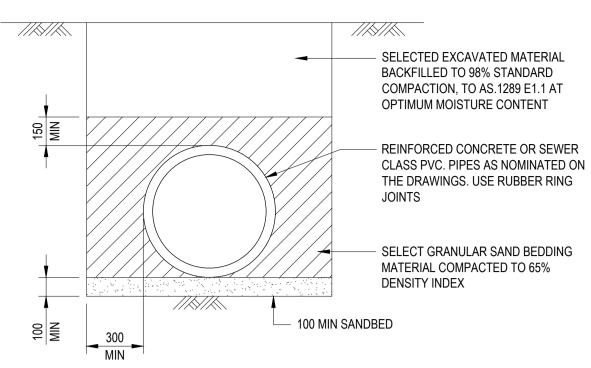
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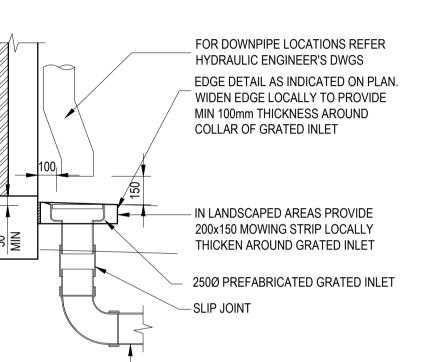




PROVIDE BENCHING TO SUIT FLOW

TYPICAL PIPE LAYING DETAIL U.N.O.

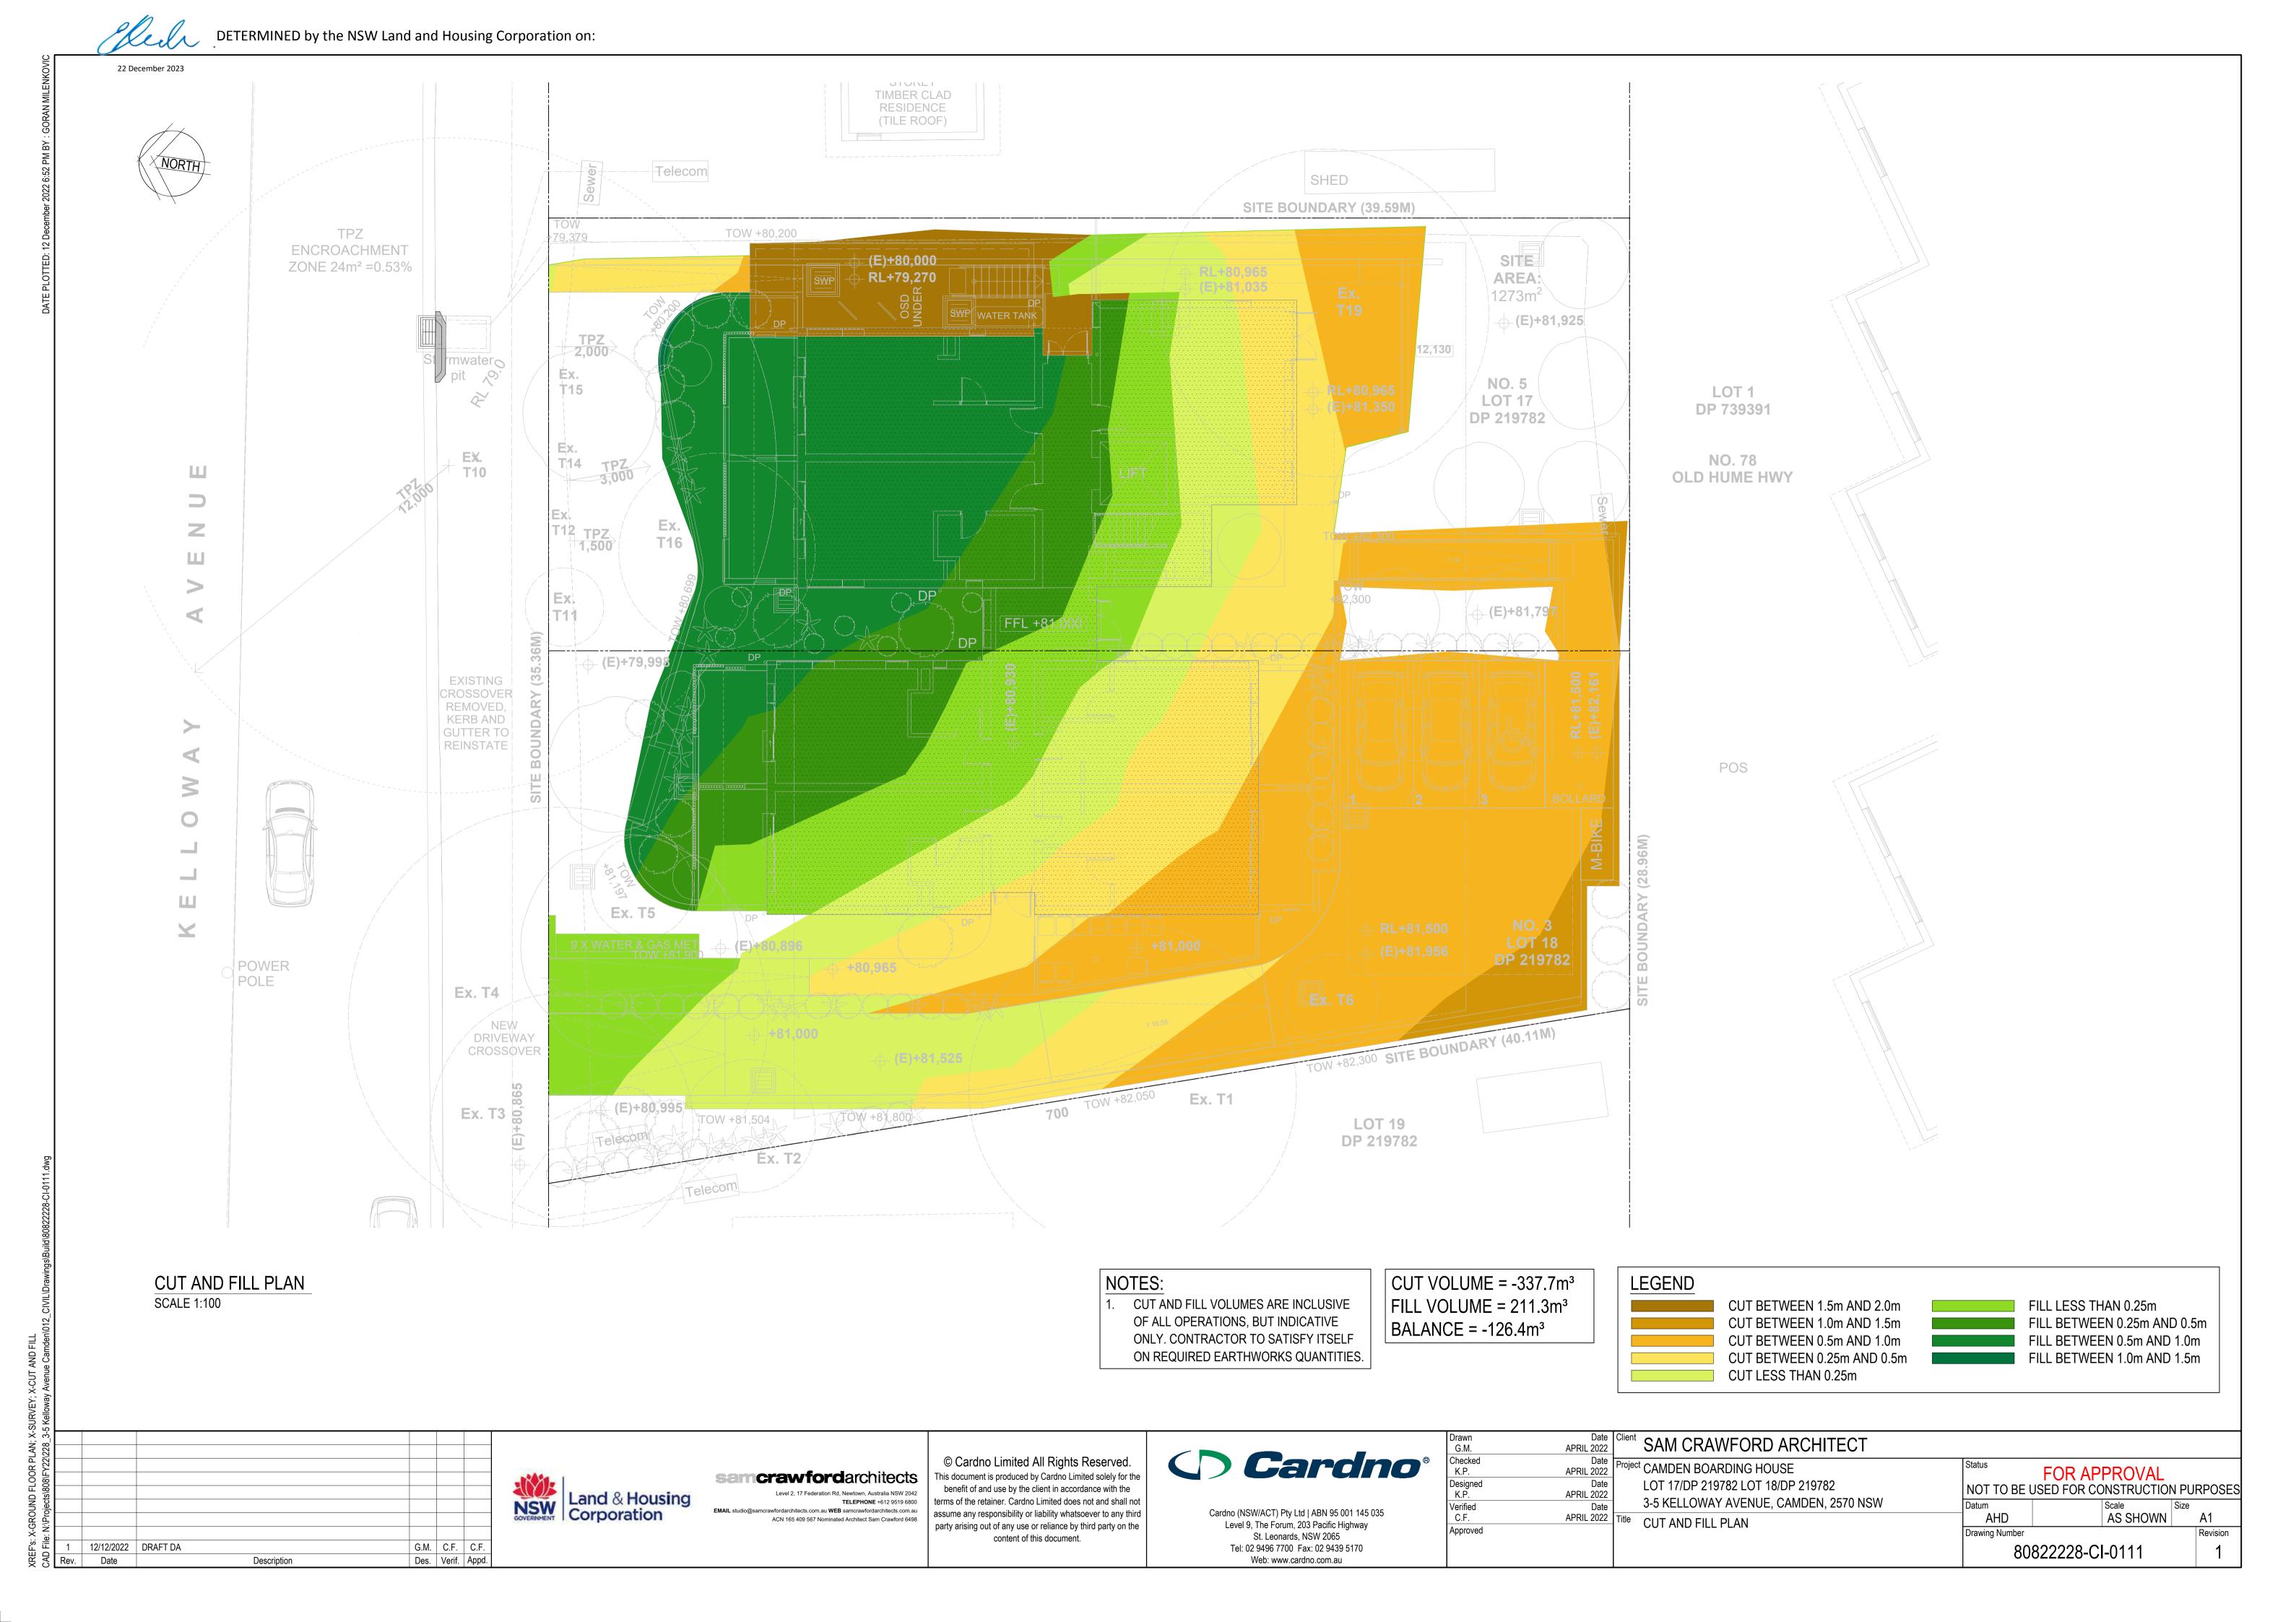ALLOW TO BUILD 100Ø AG. DRAIN IN THE LAST 3.0m OF DRAINAGE PIPE, UPSTREAM OF ALL DRAINAGE PITS.

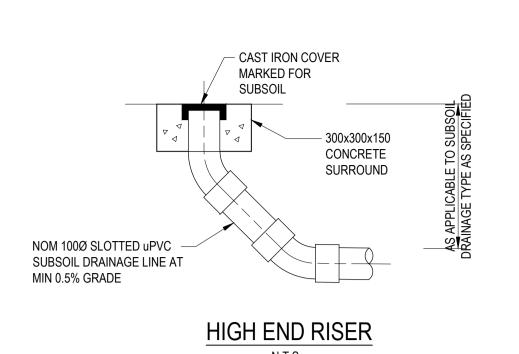

SEALANT 2222 N12-300 + R20 GALV. DOWEL BARS AT 300 CTS. x 4N12 CROSSRODS 400 LONG. BITUMEN PAINT & GREASE ONE END ONLY. PROVIDE EXPANSION GAP AS SHOWN.

GRATED DRAIN DETAIL

- 10 THICK ABELFLEX &

- REFER TO DRAWING CI-802 FOR ASPHALTIC CONCRETE PAVEMENT DETAILS. HEAVY DUTY TRENCH GRATE N12-300 + 4N12 CROSSRODS


GRATED DRAIN DETAIL AT ENTRY ROAD

DOWNPIPE CONNECTION

- KERB


– NOM. 20mm BLUE 🔃

└─ 150Ø TYP

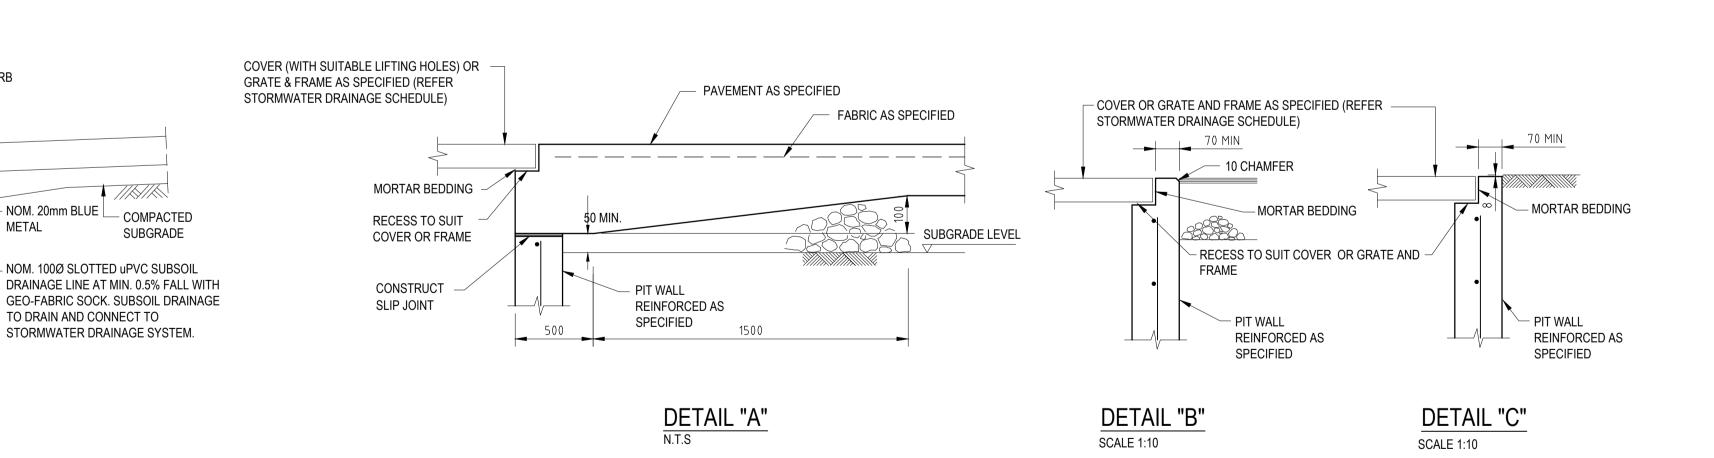

CONSTRUCT 3.0m LENGTH OF 100Ø SUBSOIL PIPE WRAPPED IN GEOFABRIC SOCK AT UPSTREAM END OF PIT PROVIDE STEP IRONS IF PIT DEEPER THAN 1200mm. (REFER DETAIL). FLOW

JUNCTION PIT SET OUT DETAILS

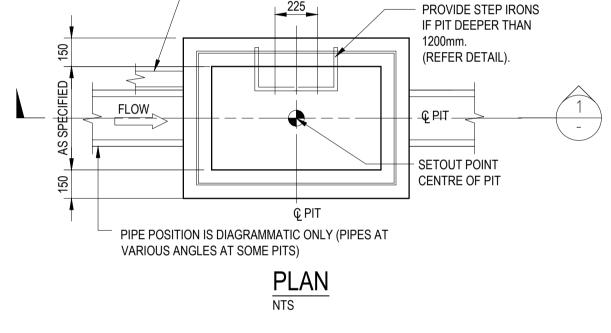

COVER (WITH SUITABLE - PIT IN CONCRETE PAVEMENT REFER DETAIL 'A' LIFTING HOLES) OR GRATE PIT IN FLEXIBLE PAVEMENT REFER DETAIL 'B' & FRAME AS SPECIFIED PIT IN LANDSCAPED AREA REFER DETAIL 'C' REFER STORMWATER DRAINAGE STRUCTURE SCHEDULE FINISHED SURFACE 70 MIN LEVEL AS SHOWN ON PLAN -N12 AT 200 MORTAR **BOTHWAYS BED TYPICAL** CENTRAL 5% CEMENT STABILISED GRANULAR BACKFILL TO SUBGRADE LEVEL AROUND STORMWATER DRAINAGE PITS IN ////// PAVEMENTS. COMPACT TO ACHIEVE MINIMUM 50 FALL UNO DENSITY INDEX EQUIVALENT TO 98% STANDARD MAXIMUM DRY DENSITY. AS SPECIFIED 150 MASS CONCRETE BENCHING. **SECTION** SCALE 1:20

SURFACE INLET/JUNCTION PIT (SIP/JP)

SUBSOIL DRAINAGE LINE IN LANDSCAPED AREAS ADJACENT TO ROADS

DENOTED \longrightarrow / \longrightarrow ON PLAN

300

GEOTEXTILE FABRIC

PIT EDGE TREATMENT FOR STORMWATER DRAINAGE AND OTHER SERVICES PITS IN ROAD PAVEMENTS AND LANDSCAPED AREAS

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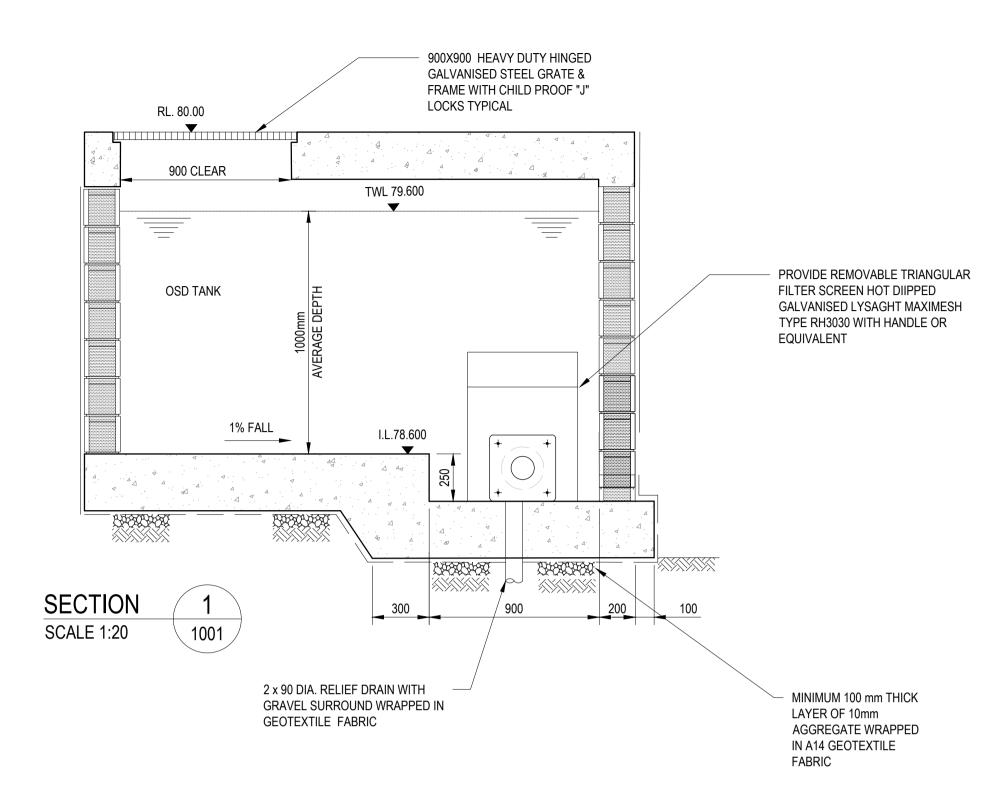
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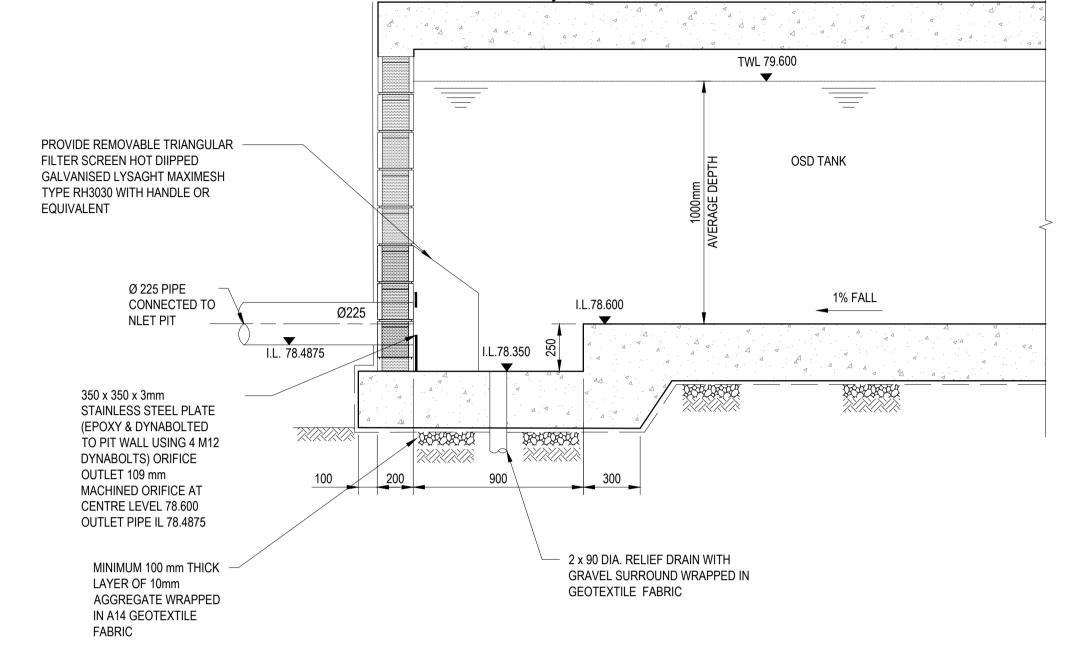


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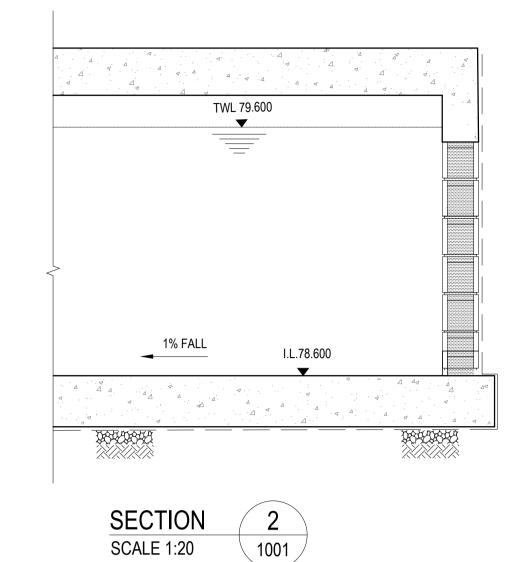
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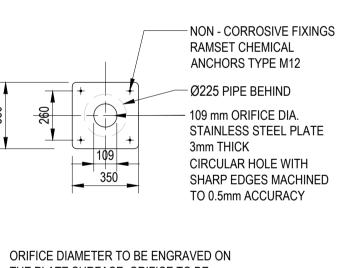
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oject CAMDEN BOARDING HOUSE LOT 17/DP 219782 LOT 18/DP 219782 3-5 KELLOWAY AVENUE, CAMDEN, 2570 NSW	FOR AP NOT TO BE USED FOR CO	PROVAL DNSTRUCTION I Scale Si	
STORMWATER STANDARD DETAILS SHEET 1	AHD Drawing Number 8082228-C	AS SHOWN -0201	A1 Revision





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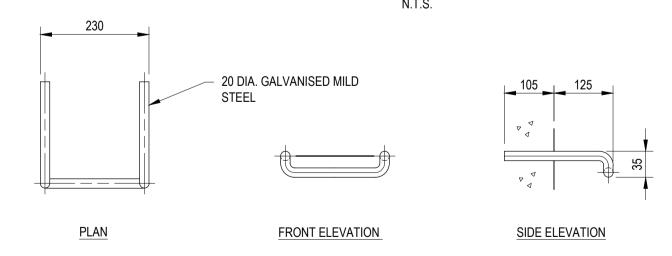
LYSAGHT MAXIMESH HANDLE-RH3030 GALVANISED OR EQUIVALENT. - ORIFICE PLATE BEYOND STEEL PLATE CLIP WELDED TO BASKET GALV. TYPICAL EITHER SIDE STEEL PLATE BRACKET GALV. FIXED TO FIT WALL WITH 2 LOXINS TO SEAT

THE PLATE SURFACE. ORIFICE TO BE EPOXY SEALED AROUND OUTER EDGES.

N.T.S.

ORIFICE PLATE DETAIL -OSD

TRASH SCREEN DETAIL



STEP IRON DETAIL

OSD SYSTEM DESIGN PARAMETER

SITE AREA = 1273 Sq m.

OSD STORAGE REQUIRED FOR SITE = 30 m3 PSD 5 MIN 5YEAR ARI =25 L/S

OSD STORAGE PROVIDED = 30.0m3

OSD TANK DETAIL DEPTH OF WATER = 1.0m TANK AREA = 30.00 m2 ORIFICE DIAMETER = 109mm

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Description

Date



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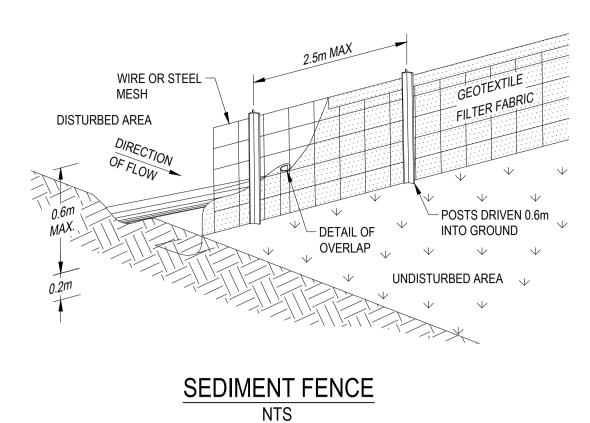
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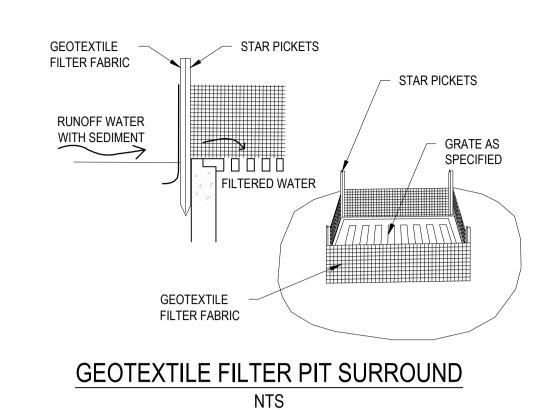
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	C.F.	APRIL 2022
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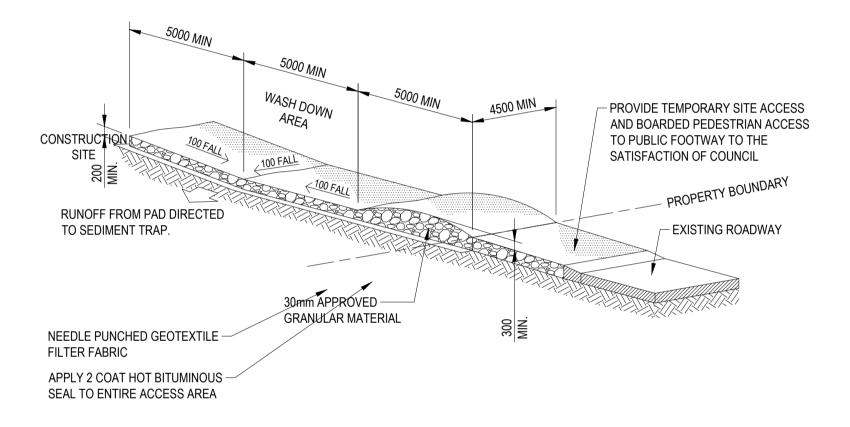
SAM CRAWFORD ARCHITECT			
3-5 KELLOWAY AVENUE, CAMDEN, 2570 NSW	NOT TO BE USED FOR CO	PROVAL ONSTRUCTION F Scale	
Title STORMWATER STANDARD DETAILS SHEET 2	Drawing Number 8082228-C		Revision 2

STRAWBALE AND GEOTEXTILE SEDIMENT FILTER


NTS








STABILISED SITE ACCESS AND TRUCK WASH DOWN AREA

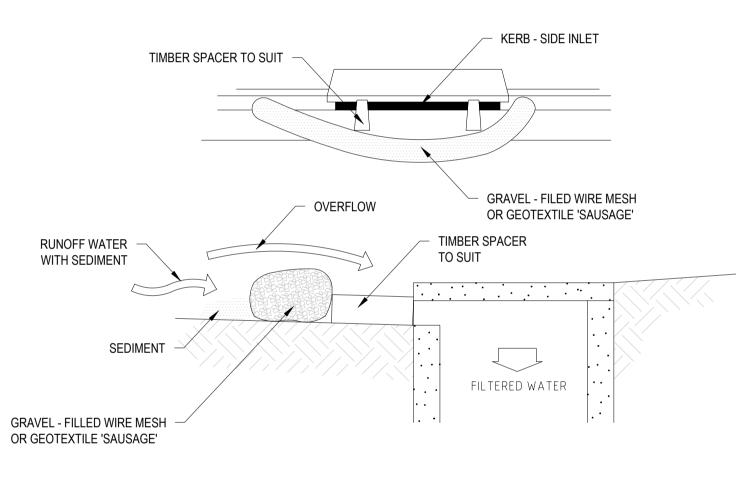

MESH AND GRAVEL INLET FILTER

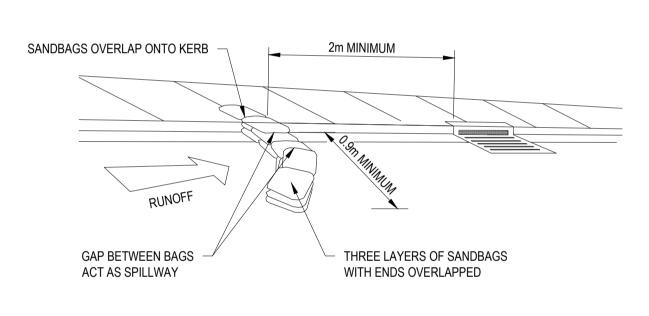

SANDBAG SEDIMENT TRAP FOR KERB INLET ON GRADE NTS

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N:\Projects\808\FY22\228	3	12/12/2022	DRAFT DA	G.M.	C.F.	C.F.	
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	Drawn	Date
	G.M.	APRIL 2022
B	Checked	Date
	K.P.	APRIL 2022
	Designed	Date
	K.P.	APRIL 2022
	Verified	Date
	C.F.	APRIL 2022
	Approved	

!	Client SAM CRAWFORD ARCHITECT
!	Project CAMDEN BOARDING HOUSE
!	LOT 17/DP 219782 LOT 18/DP 219782
!	3-5 KELLOWAY AVENUE, CAMDEN, 2570 NSW
	Title SEDIMENTATION AND EROSION
	CONTROL DETAILS

D ARCHITECT					
IOUSE 18/DP 219782	FOR APPROVAL NOT TO BE USED FOR CONSTRUCTION PURPOSES				
IE, CAMDEN, 2570 NSW	Datum		Scale AS SHOWN	Size	A1
EROSION	AHD Drawing Number		AS SHOWIN		Revision
	80822228-CI-0221				3